
# KARUK TRIBE HAPPY CAMP, CALIFORNIA

# KCDC/KTHA PARKING LOT IMPROVEMENTS

JACOBS EXTENSION 815, ROUTE NO. 0023
JULY 2013

PREPARED BY



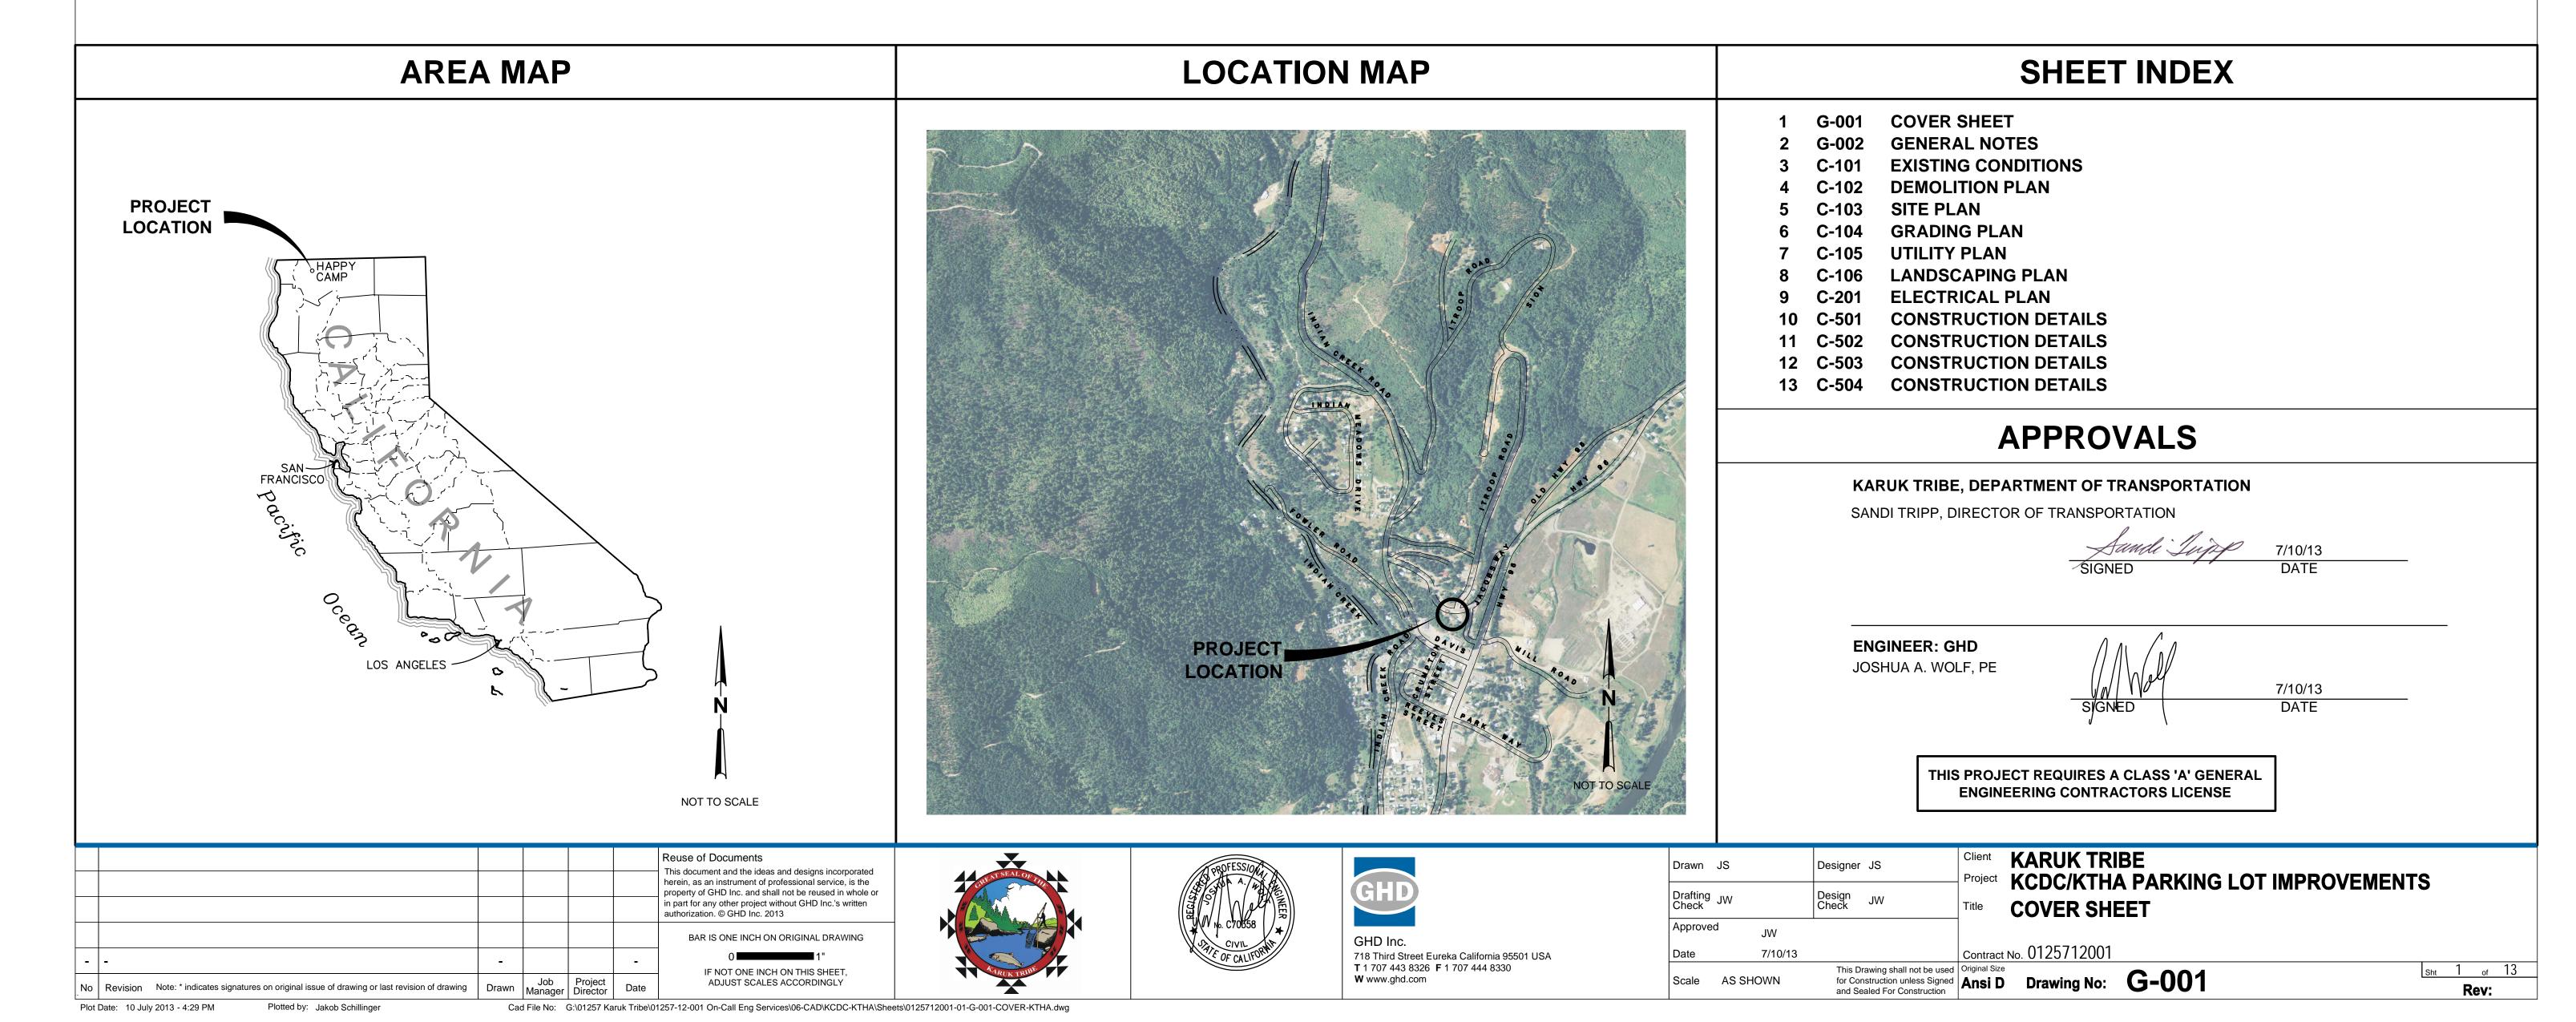

# **GENERAL NOTES**

- 1. PROJECT REQUIRES A CLASS A GENERAL ENGINEERING CONTRACTOR'S LICENSE IN THE STATE OF
- 2. CONTRACTOR SHALL FIELD VERIFY ALL EXISTING SITE CONDITIONS PRIOR TO THE COMMENCEMENT OF WORK AND REPORT ANY DISCREPANCIES TO THE OWNER'S REPRESENTATIVE. CONTRACTOR IS RESPONSIBLE FOR VISITING THE SITE AND BECOMING FAMILIAR WITH THE SITE CONDITIONS PRIOR TO BIDDING. SHOULD EXISTING CONDITIONS DIFFER FROM THOSE SHOWN OR INDICATED, OR IF IT APPEARS THAT THESE PLANS, AND SPECIFICATIONS DO NOT ADEQUATELY DETAIL THE WORK TO BE DONE, CONTRACTOR SHALL NOTIFY THE ENGINEER PRIOR TO CONTINUING WITH ANY RELATED WORK. NO ALLOWANCE WILL BE MADE ON CONTRACTOR'S BEHALF FOR ANY EXTRA EXPENSE RESULTING FROM FAILURE OR NEGLECT IN DETERMINING THE CONDITIONS UNDER WHICH WORK IS TO BE PERFORMED. NOTED DIMENSIONS TAKE PRECEDENCE OVER
- 3. QUANTITIES OF ITEMS, LENGTH OF PROJECT, AND SITE CONDITIONS SHOWN IN THE PLANS ARE APPROXIMATE. ALL MATERIALS SHALL BE FURNISHED AND INSTALLED BY THE CONTRACTOR UNLESS OTHERWISE NOTED.
- 4. CONTRACTOR AGREES TO ASSUME SOLE AND COMPLETE RESPONSIBILITY FOR THE JOB SITE DURING THE COURSE OF CONSTRUCTION OF THIS PROJECT, INCLUDING SAFETY OF ALL PERSONS AND PROPERTY; THAT THIS REQUIREMENT SHALL APPLY CONTINUOUSLY AND NOT BE LIMITED TO NORMAL WORKING HOURS; AND THAT THE CONTRACTOR SHALL DEFEND, INDEMNIFY, AND HOLD THE TRIBE, GHD, AND THEIR REPRESENTATIVES HARMLESS FROM ANY AND ALL LIABILITY, REAL AND/OR ALLEGED, IN CONJUNCTION WITH THE PERFORMANCE OF THIS PROJECT.
- 5. CONTRACTOR SHALL BE HELD RESPONSIBLE FOR ANY AND ALL DAMAGES TO EXISTING STRUCTURES, ROADS, AND UTILITIES DURING CONSTRUCTION. ALL DAMAGE SHALL BE RESTORED TO EQUAL OR BETTER CONDITION AT THE CONTRACTOR'S EXPENSE.
- 6. A SET OF SIGNED WORKING DRAWINGS AND A SET OF SPECIFICATIONS WILL BE KEPT AT ALL TIMES AT THE JOB SITE ON WHICH ALL CHANGES OR VARIATIONS IN THE WORK, INCLUDING ALL EXISTING UTILITIES, ARE TO BE RECORDED AND/OR CORRECTED DAILY AND SUBMITTED TO THE OWNER WHEN THE WORK TO BE DONE IS COMPLETED.
- 7. CONTRACTOR SHALL PROVIDE AND MAINTAIN SUFFICIENT TEMPORARY BARRIERS TO PROVIDE FOR THE SAFETY OF THE PUBLIC TO THE SATISFACTION OF THE OWNER.
- 8. CONTRACTOR SHALL NOTIFY THE ENGINEER AT LEAST 72 HOURS IN ADVANCE OF COMMENCEMENT OF ANY PART OF THE WORK AND SHALL COORDINATE CONSTRUCTION SCHEDULE ACCORDINGLY.
- 9. UNSUITABLE EXCAVATED MATERIAL SHALL BE REMOVED FROM SITE AND DISPOSED OF IN A MANNER CONSISTENT WITH APPLICABLE REGULATIONS. THE CONTRACTOR SHALL ASSUME FULL RESPONSIBILITY AND EXPENSE FOR PROPER DISPOSAL OF UNSUITABLE MATERIALS TAKEN FROM SITE.
- 10. THE DESIGN FEATURES INCLUDING HORIZONTAL AND VERTICAL ALIGNMENTS, TYPICAL SECTIONS, APPROACHES, AND OTHER DESIGN DETAILS SHOWN ON THESE DESIGN PLANS SHALL NOT BE ALTERED OR MODIFIED IN ANY WAY DURING CONSTRUCTION WITHOUT THE EXPRESSED, WRITTEN DIRECTION AND APPROVAL OF THE ENGINEER OR OWNER'S REPRESENTATIVE. DRAINAGE STRUCTURES SHALL BE INSTALLED AS SHOWN THE PLANS WITH ONLY MINOR CORRECTIONS IN LOCATION SKEW AND/OR ELEVATIONS AS NEEDED TO FIT FIELD CONDITIONS AS DETERMINED BY THE ENGINEER OR OWNER'S REPRESENTATIVE.
- 11. THE CONTRACTOR SHALL READ AND MAKE CAREFUL EXAMINATION OF THE PLANS, SPECIFICATIONS, QUANTITIES AND MATERIAL ESTIMATES AND VISIT THE SITE OF THE PROPOSED CONSTRUCTION TO BECOME FAMILIAR WITH THE SITE CONDITIONS AND LIMITATIONS BEFORE MAKING A BID. THE CONTRACTOR SHALL BE RESPONSIBLE FOR ANY AND ALL ERRORS RESULTING FROM THE FAILURE TO MAKE SUCH AN EXAMINATION. ANY INFORMATION DERIVED FROM THE MAPS, PLANS, SPECIFICATIONS, PROFILES, DRAWINGS OR FROM THE ENGINEER WILL NOT RELIEVE THE CONTRACTOR FROM ANY RISK OR FROM FULFILLING THE TERMS OF THE CONTRACT.
- 12. NO WORK SHALL BE PERFORMED OUTSIDE OF THE DESIGNATED CONSTRUCTION LIMITS WITHOUT THE APPROVAL OF THE OWNER'S REPRESENTATIVE.
- 13. THE CONTRACTOR IS RESPONSIBLE FOR COORDINATING STAGING AREAS WITH THE TRIBE.
- 14. UPON COMPLETION OF THE CONSTRUCTION PROJECT, THE CONTRACTOR SHALL LEAVE THE PROJECT AREA FREE OF DEBRIS AND UNUSED MATERIAL. ALL DAMAGE CAUSED BY THE CONTRACTOR SHALL BE RESTORED TO AN "AS GOOD OR BETTER" CONDITION.
- 15. THE CONTRACTOR SHALL BE REQUIRED TO SAWCUT OR GRIND THE EXISTING ASPHALT PAVEMENT WHERE OLD ASPHALT IS TO TIE INTO THE NEW ASPHALT PAVEMENT. THE CONTRACTOR SHALL BE REQUIRED TO TAPER THE NEW ASPHALT CONCRETE SURFACING TO MATCH THE EXISTING PAVEMENT SECTION AT TIE-IN POINTS AND TO PROVIDE FOR A SMOOTH TRANSITION AS DIRECTED BY THE OWNER'S REPRESENTATIVE.
- 16. UNLESS OTHERWISE NOTED, THE CONTRACTOR SHALL PROTECT EXISTING SURVEY MONUMENTS WITHIN WORK LIMITS. ANY MONUMENT DAMAGED BY THE CONTRACTOR SHALL BE RESET IN ACCORDANCE WITH THE CALIFORNIA PROFESSIONAL LAND SURVEYORS ACT.

# GRADING NOTES

- 1. CONTRACTOR SHALL BE RESPONSIBLE FOR THE SAFETY OF ALL CONSTRUCTION. ADEQUATE SHORING, BRACING, TIES, AND SUPPORTS SHALL BE USED TO PROVIDE PROPER TEMPORARY INTEGRITY DURING ALL PHASES OF CONSTRUCTION.
- 2. ALL EXISTING LANDSCAPED AND UNPAVED AREAS WHICH ARE DISTURBED BY CONSTRUCTION OR EARTHWORK OPERATIONS SHALL BE RETURNED TO ORIGINAL EXISTING CONDITIONS.

No Revision Note: \* indicates signatures on original issue of drawing or last revision of drawing Drawn Manager Director Date

- 3. ALL DITCHES, SWALES, GUTTERS, ETC. SHOULD BE CONSIDERED ACTIVE STORM CONVEYANCES UNLESS OTHERWISE INDICATED. CONTRACTOR IS RESPONSIBLE FOR ADDRESSING STORM WATER DRAINAGE AND DEWATERING OF WORK AREAS DURING CONSTRUCTION.
- 4. DURING WET WEATHER PERIODS, CONTRACTOR IS RESPONSIBLE FOR SEQUENCING CONSTRUCTION IN A MANNER TO MINIMIZE IMPACT ON OPEN EARTHWORK AND COMPACTION OPERATIONS.

#### **UTILITY NOTES**

- LOCATIONS OF EXISTING UTILITIES AND STRUCTURES ARE FROM THE BEST INFORMATION AVAILABLE. EXACT LOCATION AND COMPLETENESS ARE NOT GUARANTEED. CONTRACTOR SHALL NOTIFY UNDERGROUND SERVICES ALERT (800) 227-2600 A MINIMUM OF 48 HOURS PRIOR TO ANY EXCAVATION AND POTHOLE FOR EXACT LOCATION, NOTIFY THE ENGINEER IMMEDIATELY IF LOCATE INDICATES THAT EXISTING UTILITIES ARE DIFFERENT THAN SHOWN ON DRAWINGS.
- 2. LOCATIONS OF EXISTING UNDERGROUND UTILITIES ARE PLOTTED FROM RECORD INTERPOLATION OF PHYSICAL EVIDENCE ON THE SITE AND ARE SUBJECT TO FIELD VERIFICATION BY THE CONTRACTOR.
- 3. ALL LOCATIONS FOR WORK SHALL BE CHECKED AND COORDINATED WITH EXISTING CONDITIONS IN THE FIELD BEFORE BEGINNING CONSTRUCTION UNDER THIS SECTION OR ANY OTHER SECTION.
- 4. CONTRACTOR IS RESPONSIBLE FOR ANY DAMAGE TO UTILITIES, FEATURES, AND STRUCTURES LOCATED ON THE SITE, LOCATE, PROTECT, AND AVOID DISRUPTION OF ALL ABOVE AND BELOW GRADE UTILITIES DURING
- CONSTRUCTION ACTIVITY WILL TAKE PLACE IN THE VICINITY OF UNDERGROUND ELECTRIC TRANSMISSION LINES. IT IS THE CONTRACTOR'S RESPONSIBILITY TO BE AWARE OF, AND OBSERVE, THE MINIMUM CLEARANCES FOR WORKERS AND EQUIPMENT OPERATING NEAR HIGH VOLTAGE ELECTRIC LINES AS SET OUT IN THE HIGH VOLTAGE SAFETY ORDERS OF THE CALIFORNIA DIVISION OF INDUSTRIAL SAFETY AS WELL AS OTHER APPLICABLE SAFETY REGULATIONS.


#### WATER POLLUTION CONTROL NOTES

- 1. AT A MINIMUM, THE CONTRACTOR SHALL EMPLOY THE FOLLOWING BEST MANAGEMENT PRACTICES (BMPS) AS DESCRIBED IN THE CURRENT CALIFORNIA STORMWATER BMP HANDBOOK FOR CONSTRUCTION (WWW.CASQA.ORG):
  - EC-1 SCHEDULING
  - EC-2 PRESERVATION OF EXISTING VEGETATION
  - EC-4 HYDROSEEDING
  - SE-1 SILT FENCE SE-5 FIBER ROLLS
  - SE-7 STREET SWEEPING AND VACUUMING
  - STORM DRAIN INLET PROTECTION SE-10
  - WIND EROSION CONTROL WE-1 NS-3 PAVING AND GRINDING OPERATIONS
  - NS-9 VEHICLE EQUIPMENT AND FUELING
  - NS-10 **VEHICLE & EQUIPMENT MAINTENANCE**
  - WM-1 MATERIALS DELIVERY AND STORAGE WM-2 MATERIAL USE
  - WM-3 STOCKPILE MANAGEMENT
  - WM-4 SPILL PREVENTION AND CONTROL
  - WM-5 SOLID WASTE MANAGEMENT CONCRETE WASTE MANAGEMENT
  - WM-8
  - SANITARY/SEPTIC WASTE MANAGEMENT
- 2. IT IS THE RESPONSIBILITY OF THE CONTRACTOR TO MINIMIZE EROSION AND PREVENT THE TRANSPORT OF SEDIMENT TO SENSITIVE AREAS.
- 3. SUFFICIENT EROSION CONTROL SUPPLIES SHALL BE AVAILABLE ON-SITE AT ALL TIMES TO DEAL WITH AREAS SUSCEPTIBLE TO EROSION DURING RAIN EVENTS.
- MINIMIZE DISTURBANCE OF EXISTING VEGETATION TO THAT NECESSARY TO COMPLETE THE WORK.
- 5. THE CONTRACTOR SHALL MAKE ADEQUATE PREPARATIONS, INCLUDING TRAINING & EQUIPMENT, TO CONTAIN SPILLS OF OIL AND OTHER HAZARDOUS MATERIALS.
- 6. ACTIVITIES SUCH AS VEHICLE WASHING ARE TO BE CARRIED OUT AT AN OFF-SITE FACILITY WHEREIN THE WATER IS DISCHARGED INTO A SANITARY SEWER.
- 7. THE CONTRACTOR SHALL PROVIDE COVERED WASTE RECEPTACLE FOR COMMON SOLID WASTES AT CONVENIENT LOCATIONS ON THE JOB SITE AND PROVIDE REGULAR COLLECTION OF WASTES.
- 8. THE CONTRACTOR SHALL PROVIDE SANITARY FACILITIES OF SUFFICIENT NUMBER AND SIZE TO ACCOMMODATE CONSTRUCTION CREWS AND ENSURE ADEQUATE ANCHORAGE OF SUCH FACILITIES TO PREVENT THEM FROM BEING TIPPED BY THE WEATHER OR VANDALISM.
- 9. APPROPRIATE STORAGE AND DISPOSAL OF WATER FROM DEWATERING OPERATIONS SHALL BE EXERCISED IN THE EVENT THAT ACCUMULATED WATER MUST BE REMOVED FROM A WORK LOCATION.
- 10. COVERED AND SECURED STORAGE AREAS FOR POTENTIALLY TOXIC MATERIALS SHALL BE PROVIDED. ALL HAZARDOUS MATERIAL CONTAINERS SHOULD BE PLACED IN SECONDARY CONTAINMENT.
- 11. VEHICLE AND EQUIPMENT & MAINTENANCE SHOULD BE PERFORMED OFF-SITE WHENEVER PRACTICAL.
- 12. SOIL STOCKPILES SHALL BE COVERED, AND LOCATED AT LEAST 50 FEET AWAY FROM DRAINAGE CHANNELS AND STORMWATER SYSTEMS.
- 13. CONTRACTOR MUST ENSURE THAT THE CONSTRUCTION SITE IS PREPARED PRIOR TO THE ONSET OF ANY
- 14. ALL SEDIMENT DEPOSITED ON PAVED ROADWAYS SHALL BE SWEPT AT THE END OF EACH WORKING DAY, AS NECESSARY OR AS DIRECTED BY THE OWNERS REPRESENTATIVE. A STABILIZED CONSTRUCTION ENTRANCE MAY BE REQUIRED TO PREVENT SEDIMENT FROM BEING DEPOSITED ON PAVED ROADWAYS.
- 15. ALL EROSION AND SEDIMENT CONTROL MEASURES SHALL BE MAINTAINED IN ACCORDANCE TO THEIR RESPECTIVE BMP FACT SHEET UNTIL DISTURBED AREAS ARE STABILIZED.
- 16. THIS PLAN MAY NOT COVER ALL THE SITUATIONS THAT ARISE DURING CONSTRUCTION DUE TO UNANTICIPATED FIELD CONDITIONS. VARIATIONS MAY BE MADE TO THE PLAN IN THE FIELD SUBJECT TO THE APPROVAL OF OR AT THE DIRECTION OF THE OWNERS REPRESENTATIVE.
- 17. IT WILL BE THE RESPONSIBILITY OF THE CONTRACTOR TO FIX ANY DEFICIENCIES INDICATED BY THE OWNER OR THE OWNERS REPRESENTATIVE TO PREVENT EROSION AND CONTROL SEDIMENT.
- 18. PRIOR TO FINAL ACCEPTANCE ALL AREAS OF THE SITE SHALL BE PERMANENTLY STABILIZED WITH HYDROSEED BY CONTRACTOR AND TEMPORARY SEDIMENT CONTROL MEASURES SHALL BE REMOVED AS DIRECTED.

#### TRAFFIC CONTROL NOTES

- 1. TEMPORARY TRAFFIC CONTROL MEASURES SHALL CONFORM TO THE CALIFORNIA MANUAL ON UNIFORM TRAFFIC CONTROL DEVICES (MUTCD), CURRENT EDITION.
- 2. THE CONTRACTOR SHALL PROVIDE ACCESS TO ALL BUILDINGS AT ALL TIMES.
- 3. CONTRACTOR SHALL PROVIDE TEMPORARY PEDESTRIAN ACCESS DURING CONSTRUCTION AND SHALL COMPLY WITH SECTION 7-1.08 AND 7-1.09 OF THE CALTRANS STANDARD SPECIFICATIONS.
- 4. CONTRACTOR SHALL PROVIDE AND MAINTAIN SUFFICIENT TEMPORARY BARRIERS TO PROVIDE FOR THE SAFETY OF THE STAFF AND PUBLIC TO THE SATISFACTION OF THE ENGINEER.
- 5. PROVIDE EMERGENCY VEHICLE INGRESS/EGRESS ACCESS AS NEEDED AT ALL TIMES.

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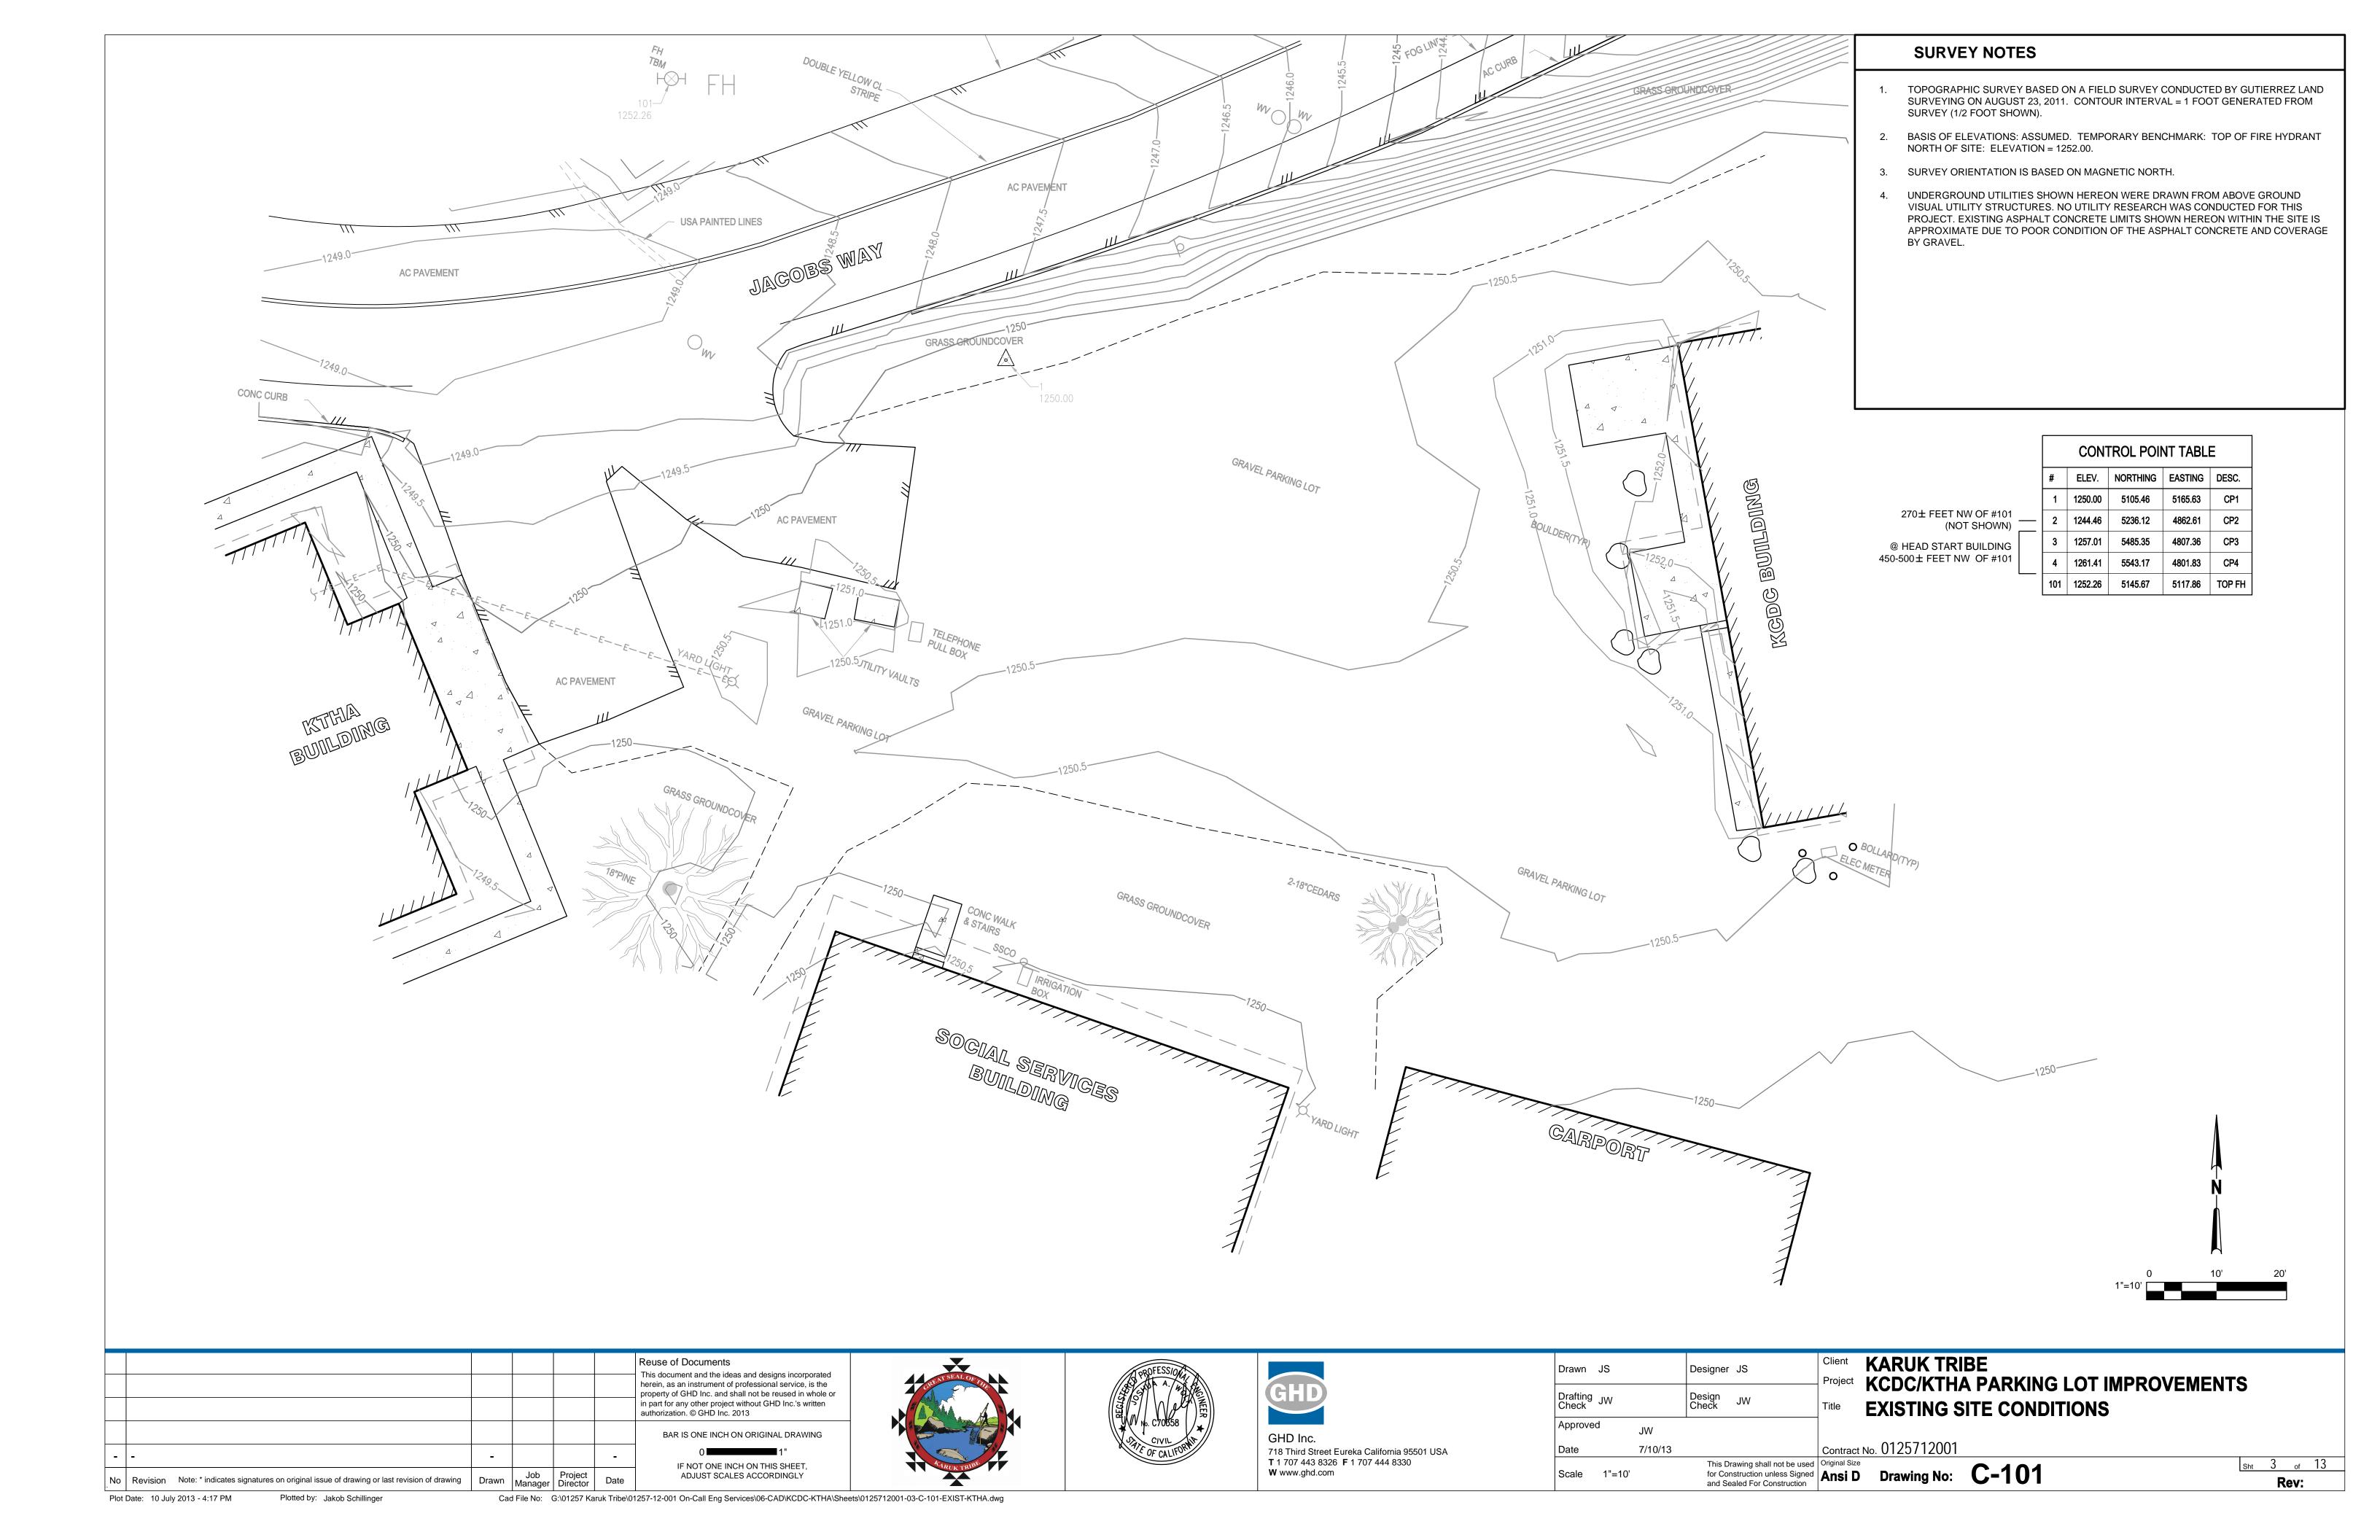
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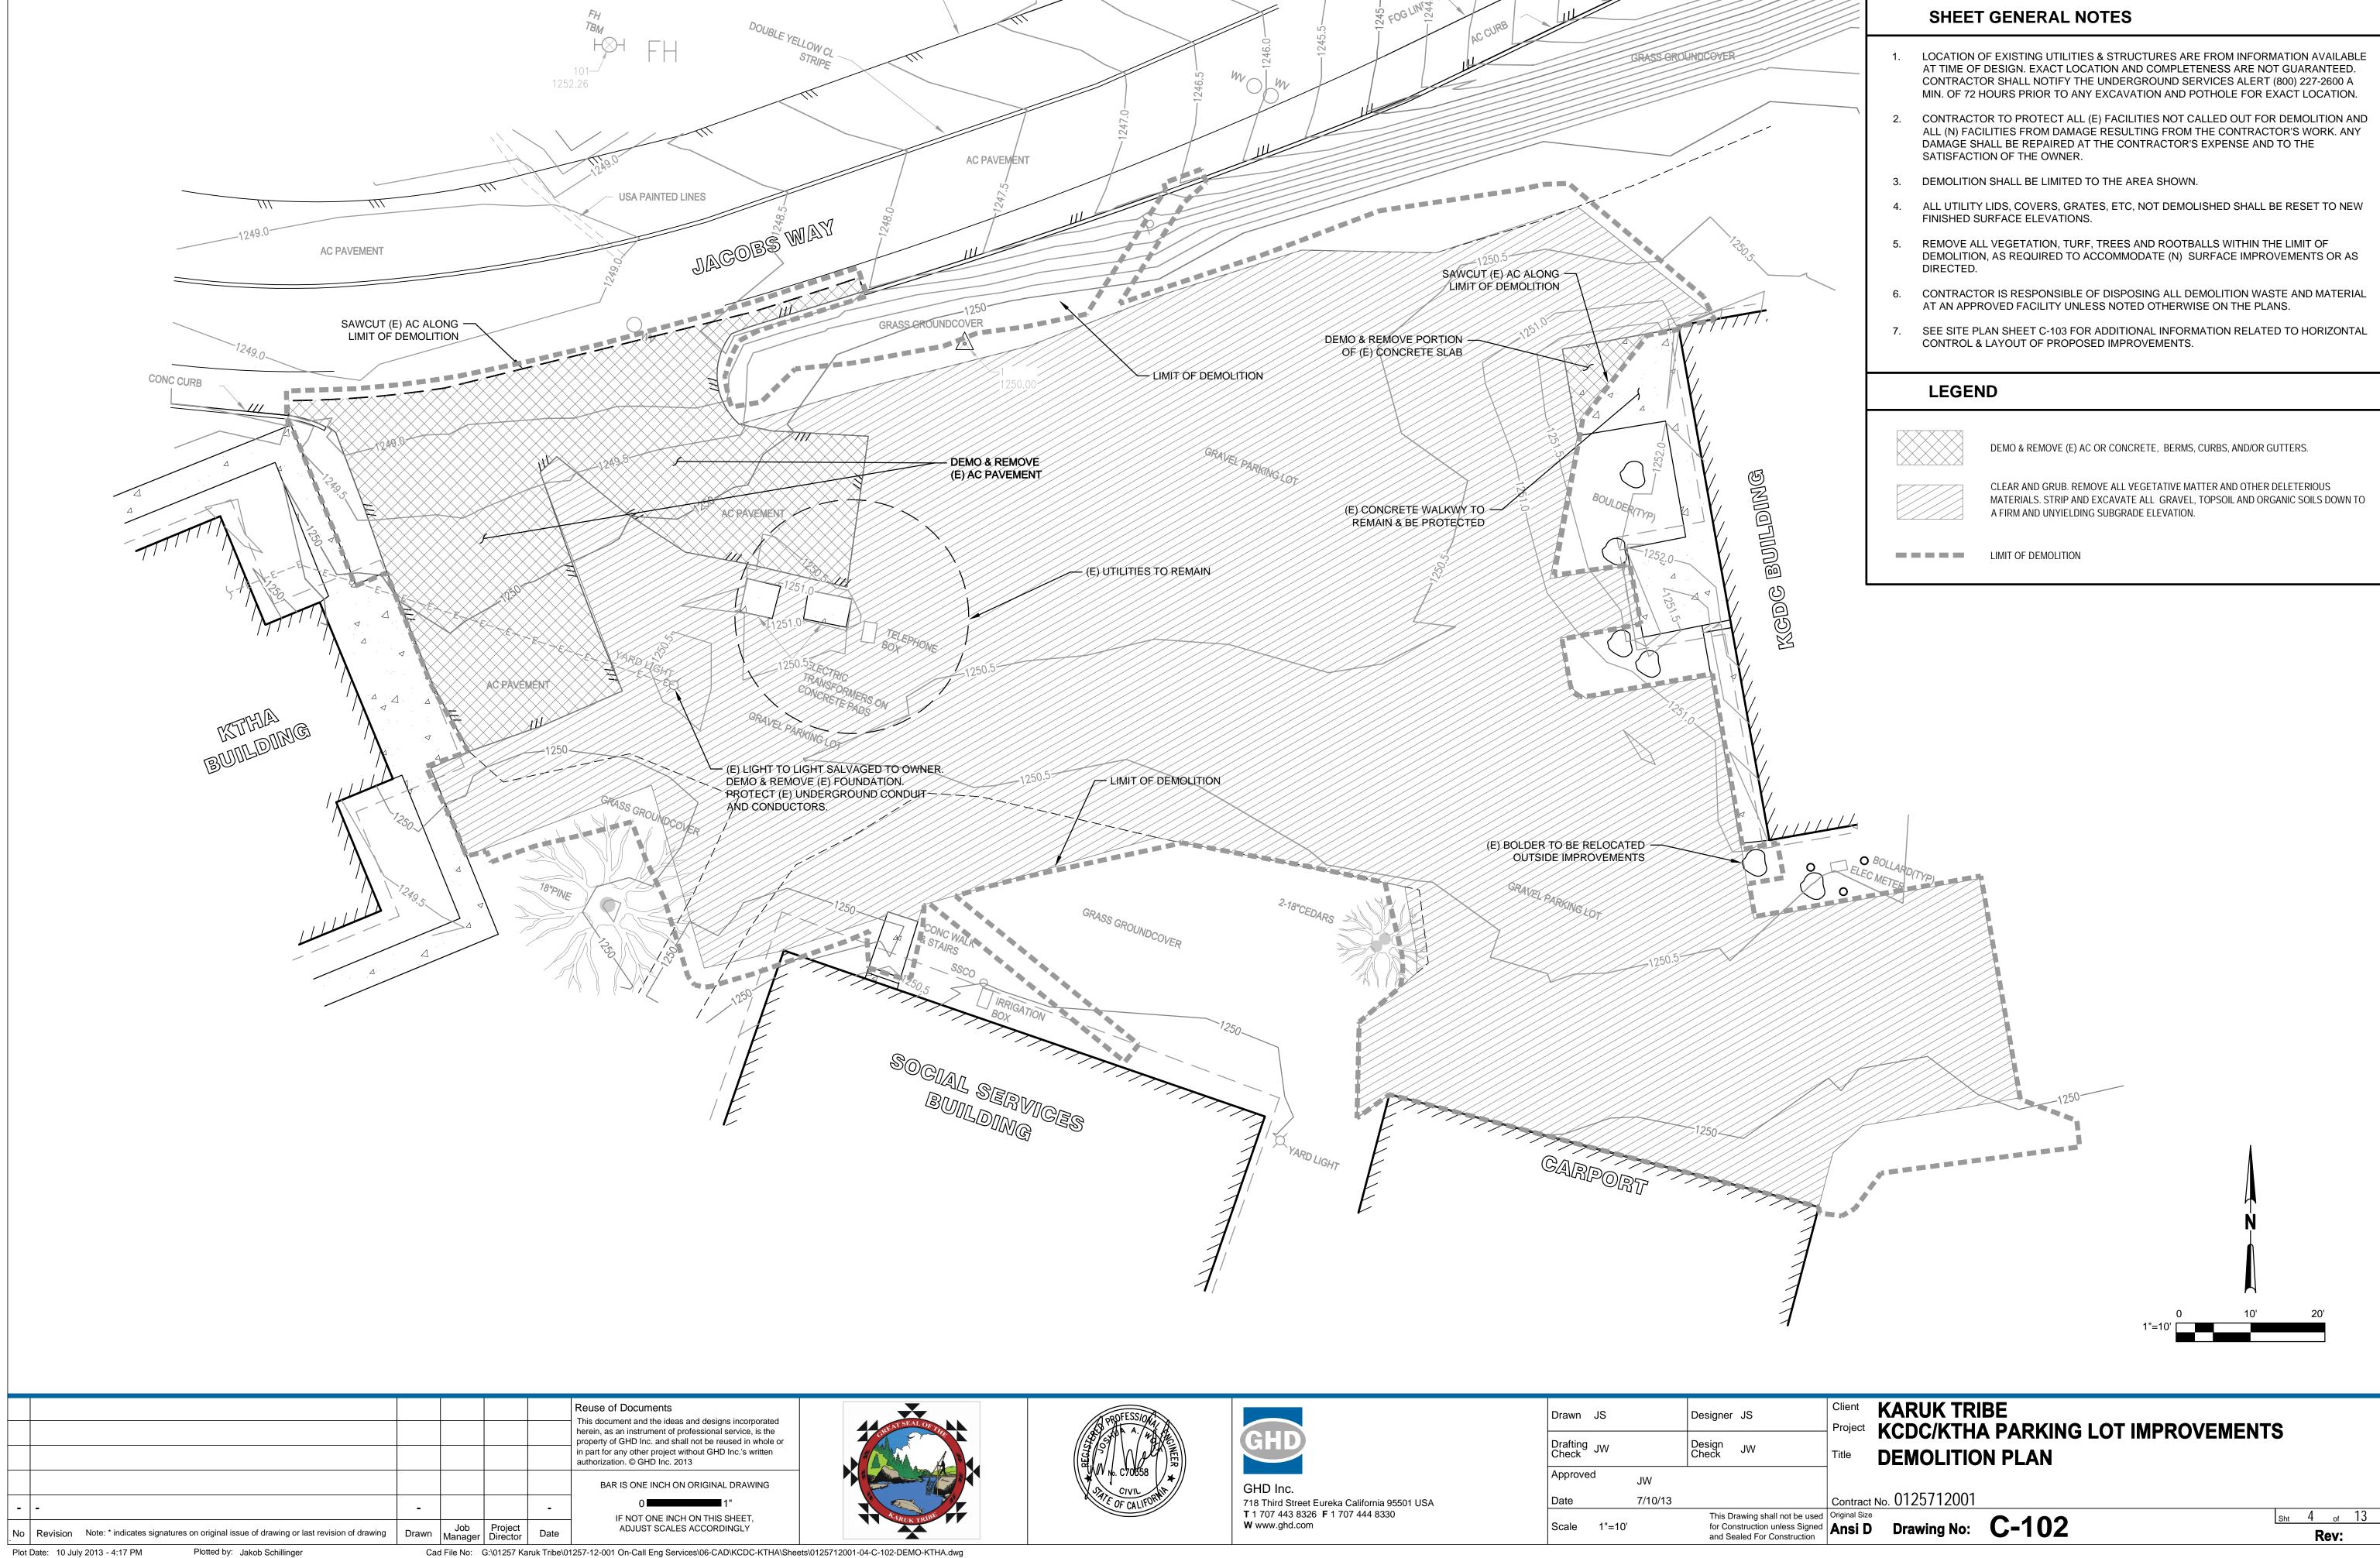
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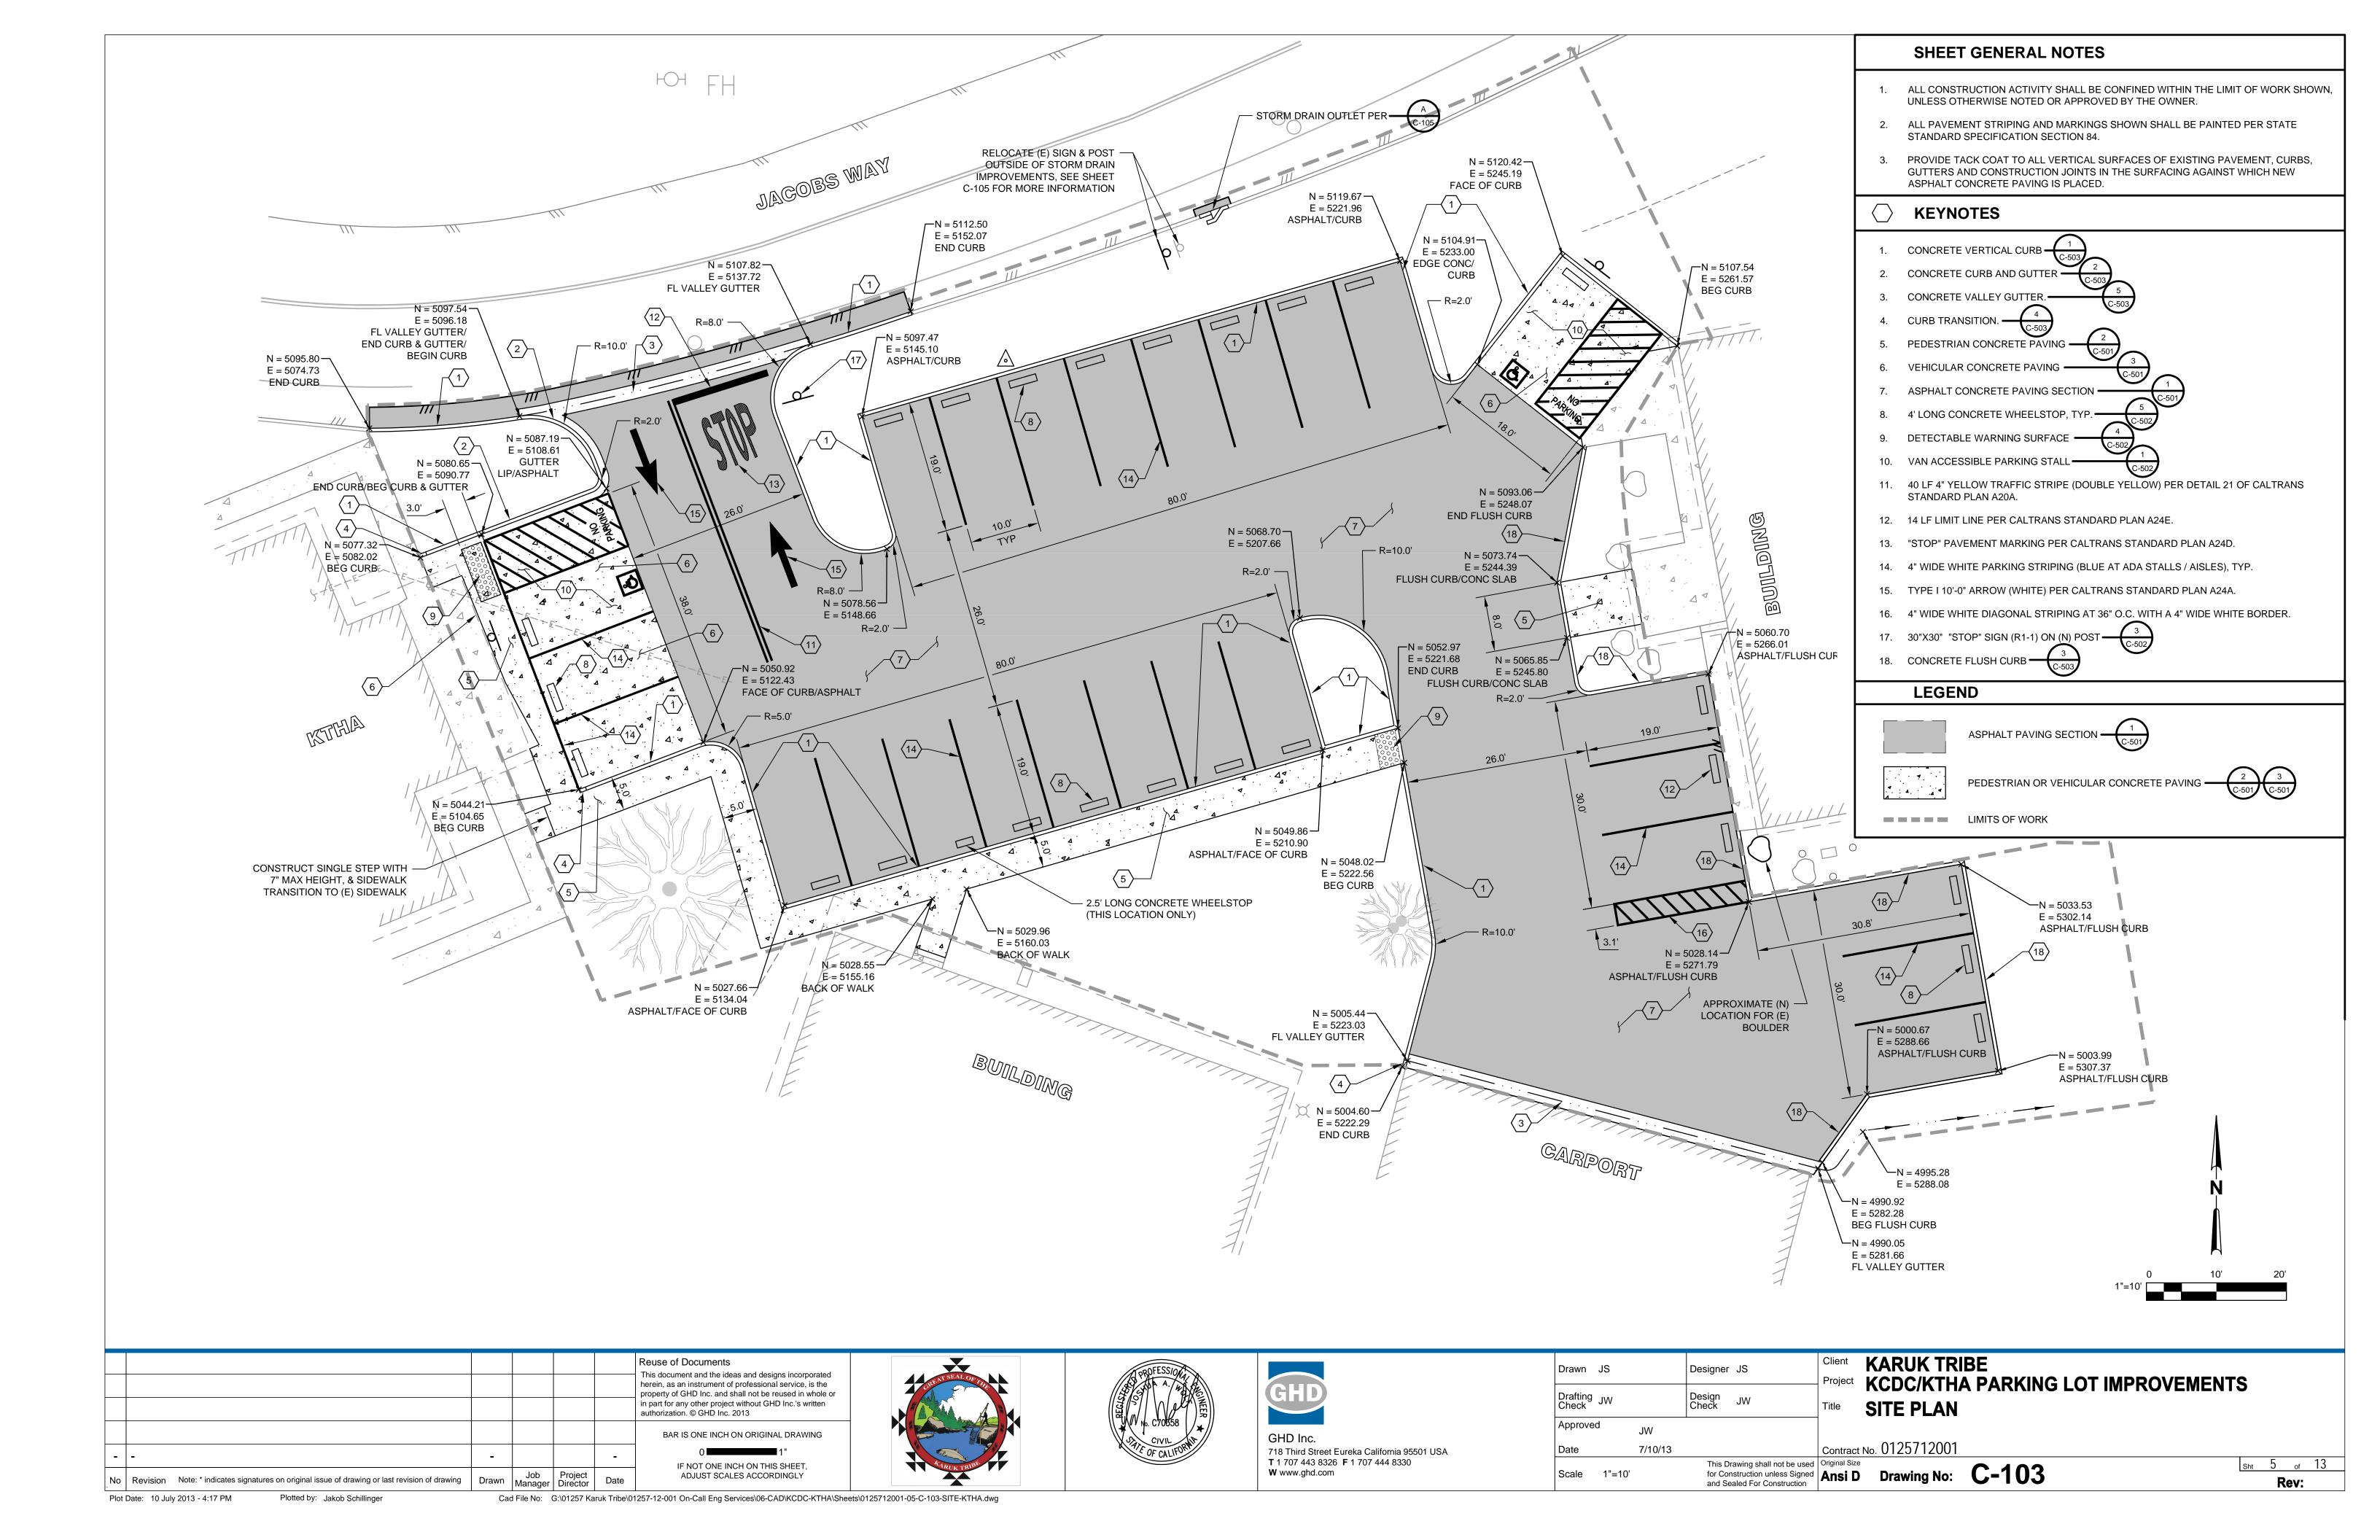
**KARUK TRIBE** KCDC/KTHA PARKING LOT IMPROVEMENTS **GENERAL NOTES** 

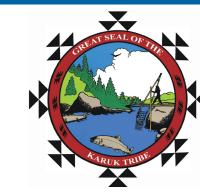
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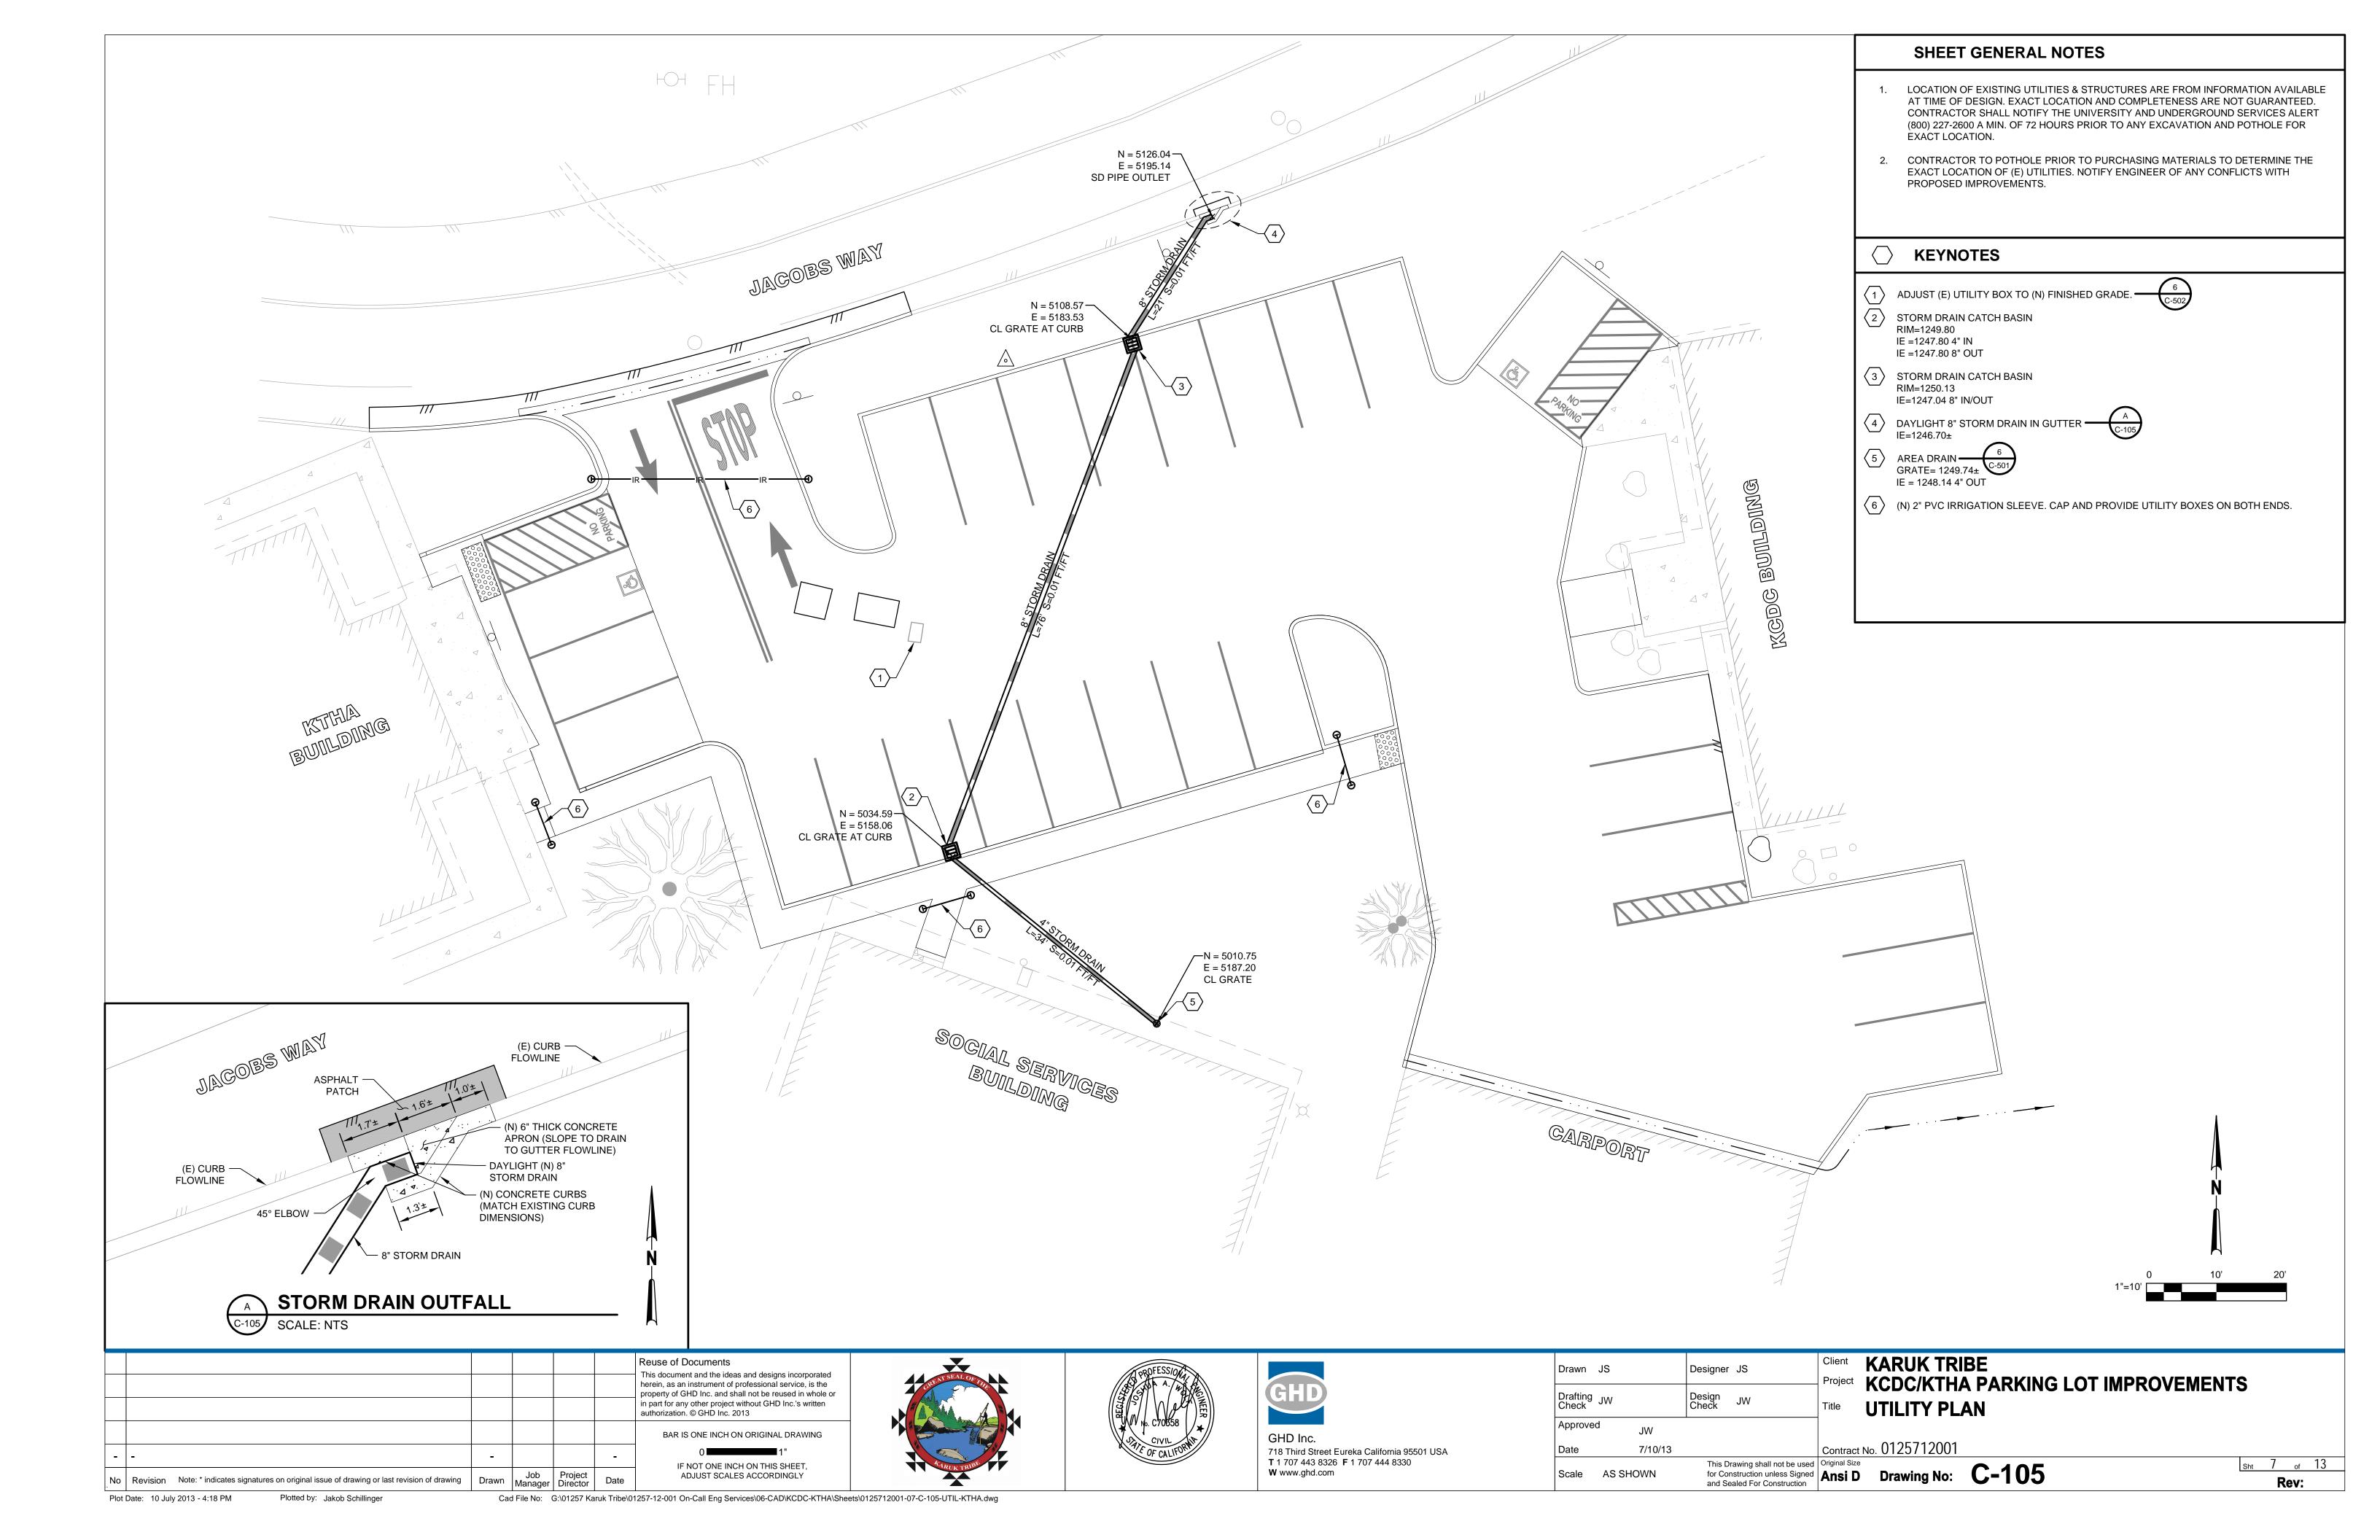
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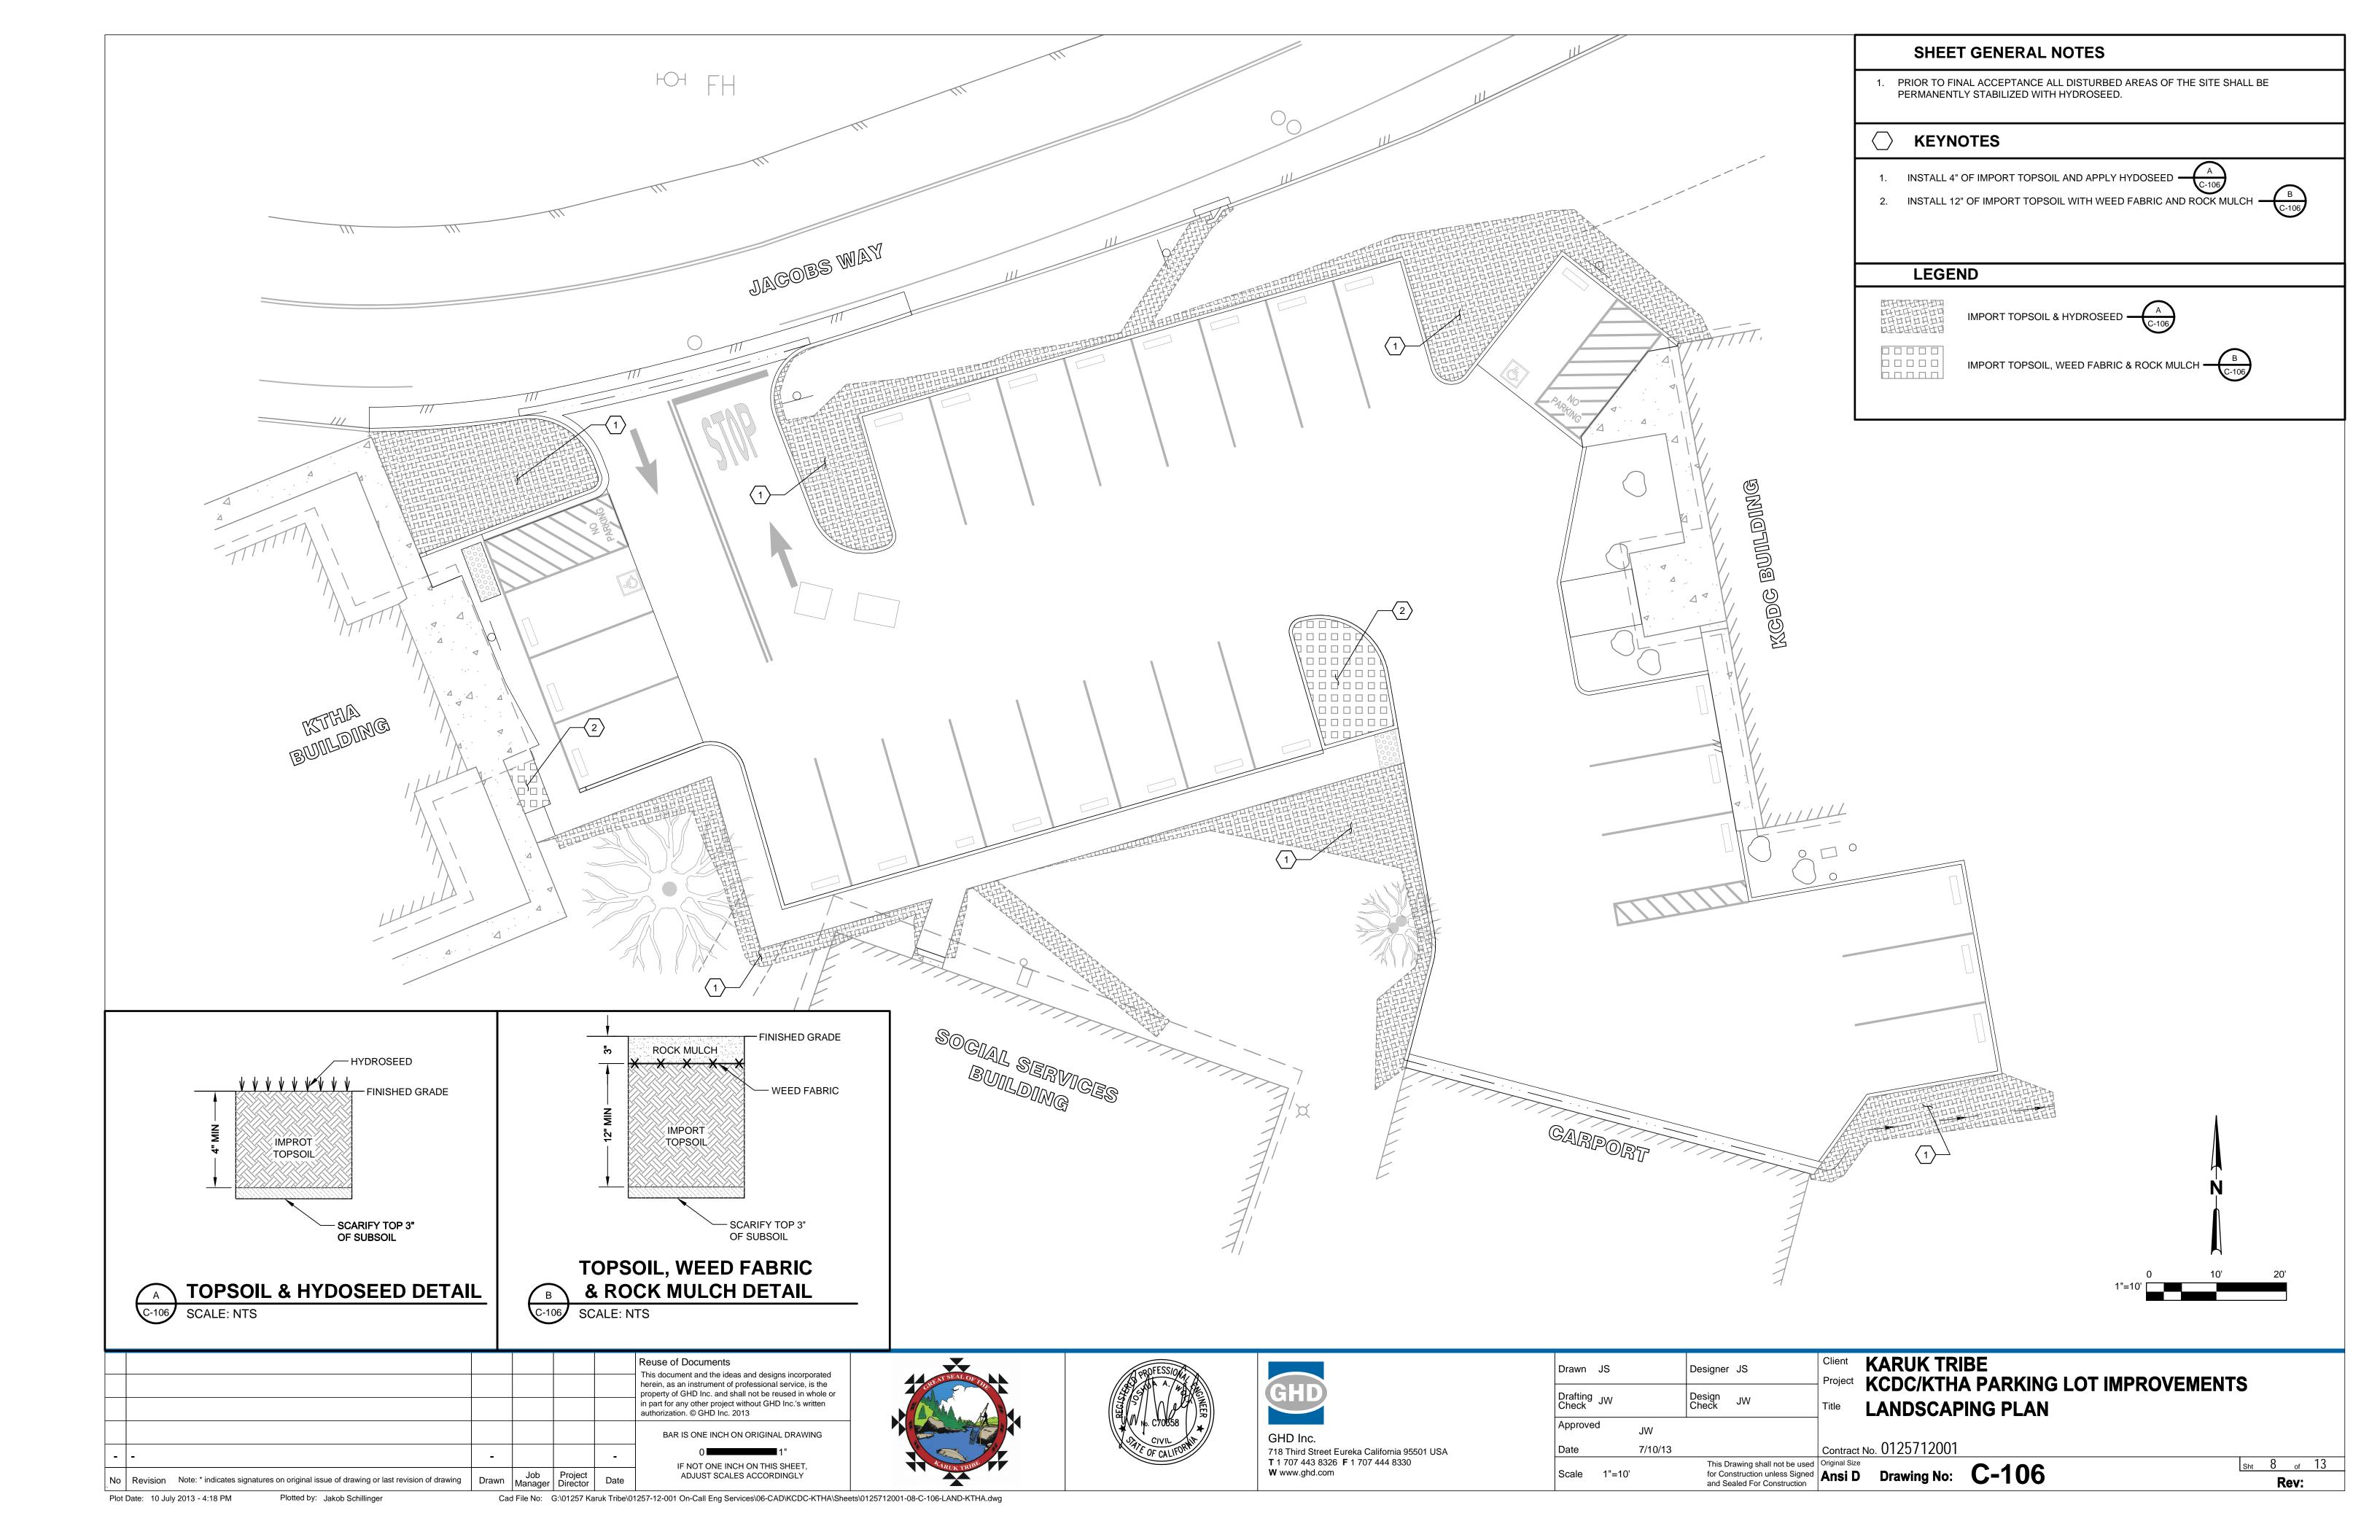












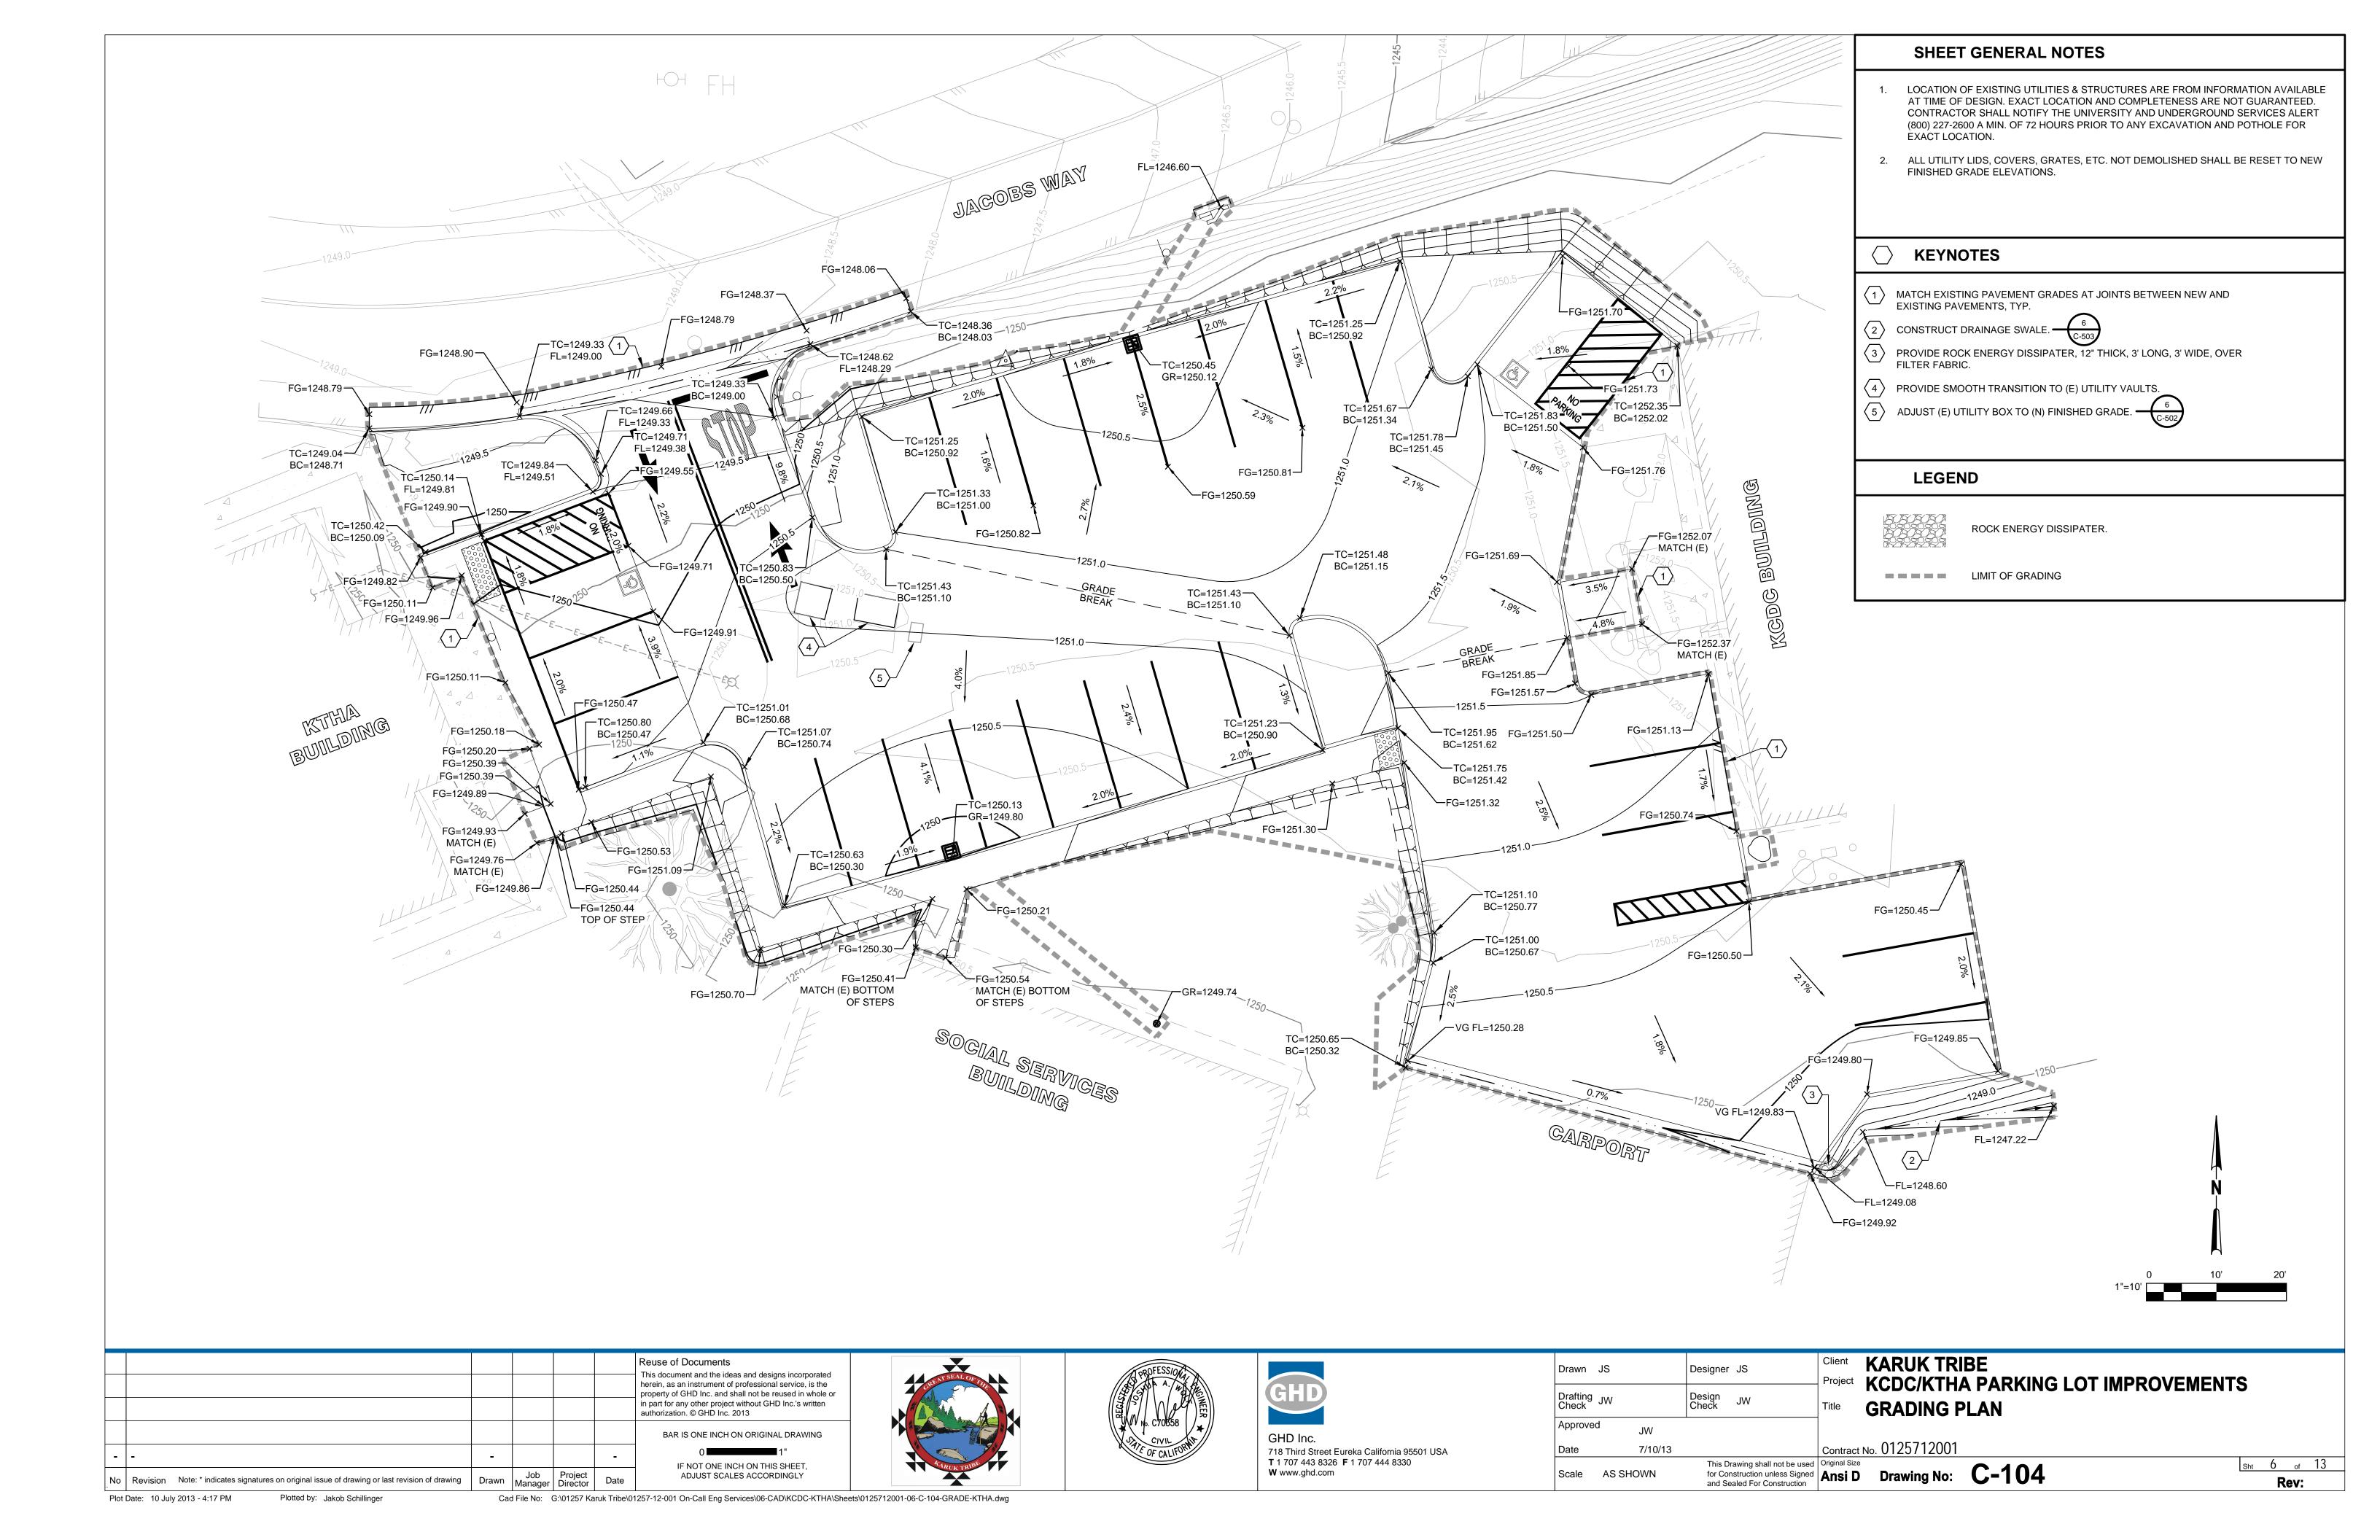

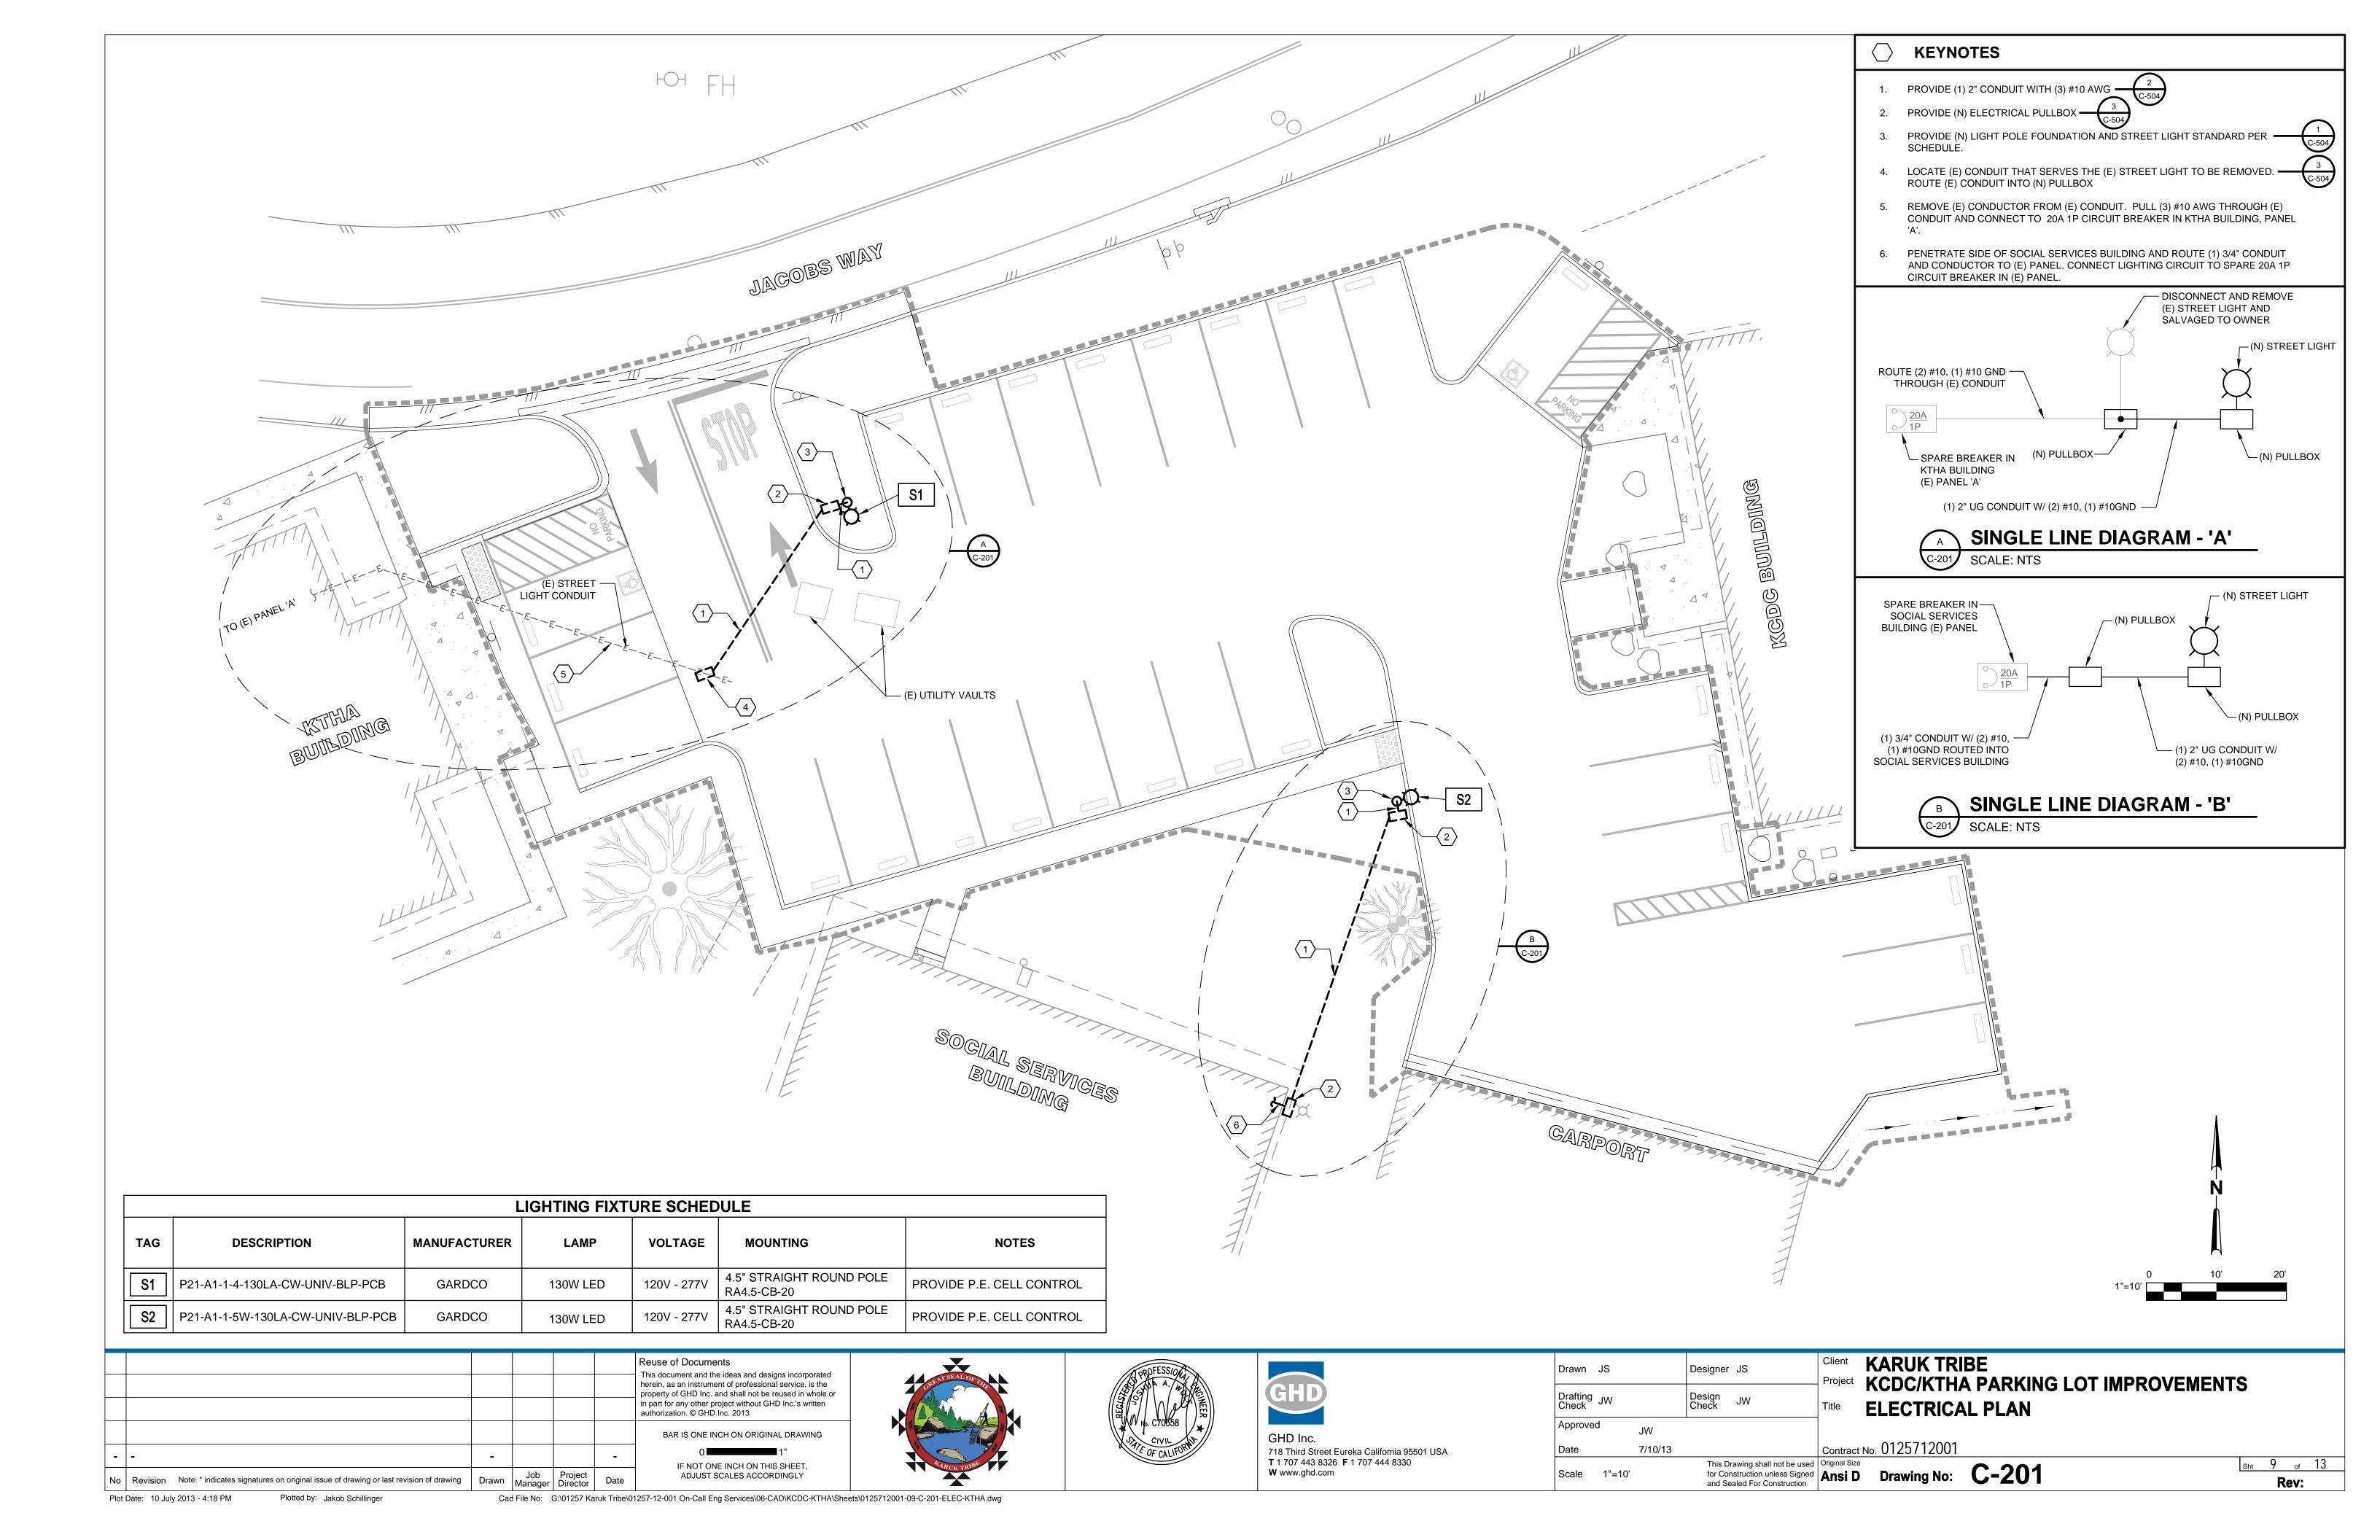

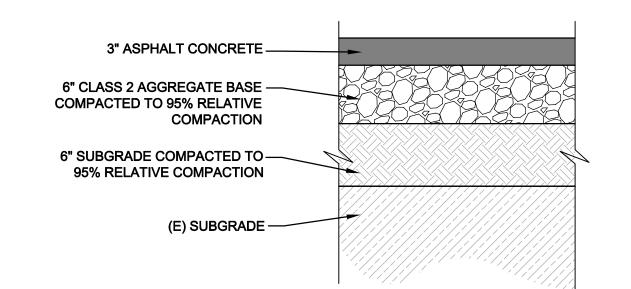



# TYPICAL ASPHALT PAVING SECTION

SCALE: NTS

# - #2 BAR CENTERED @ 24" O.C., BOTH WAYS OR WELDED WIRE FABRIC -6X6 -W10xW10 - COMPACTED AGG. BASE 95% RELATIVE COMPACTION — 6" SUBGRADE COMPACTED TO 95% RELATIVE COMPACTION


#### NOTES:

- 1. DRILL AND DOWEL #3'S @ 24" O.C. INTO (E) SIDEWALKS/WALKWAYS.
- 2. WALKS AND SIDEWALKS SHALL CONFORM TO SECTION 1133B.7, WALKS AND SIDEWALKS, OF THE
- 3. SLOPE CONCRETE PAVING SECTIONS AWAY FROM BUILDINGS AND OTHER STRUCTURES AND TOWARDS STREETS AND DRAINAGE FACILITIES.
- 4. MAXIMUM CROSS SLOPE OF SIDEWALKS AND WALKWAYS SHALL BE 2%.
- 5. PROVIDE JOINTS PER  $\frac{4}{\text{C-501}}$



PAVED AREAS UNPAVED AREAS

SCALE: NTS

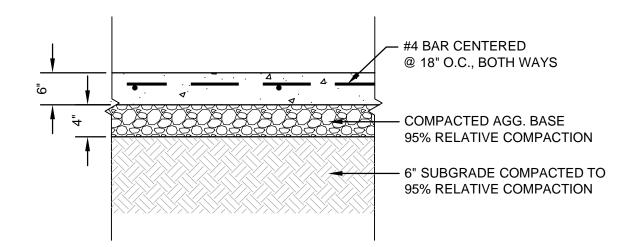


#### NOTES:

- 1. DRILL AND DOWEL #4'S @ 24" O.C. INTO (E) CONCRETE SLABS..
- 2. SLOPE CONCRETE PAVING SECTIONS AWAY FROM BUILDINGS AND OTHER STRUCTURES AND TOWARDS STREETS AND DRAINAGE FACILITIES.
- 3. PROVIDE JOINTS PER  $\begin{pmatrix} 4 \\ C-501 \end{pmatrix}$





C-501 SCALE: NTS

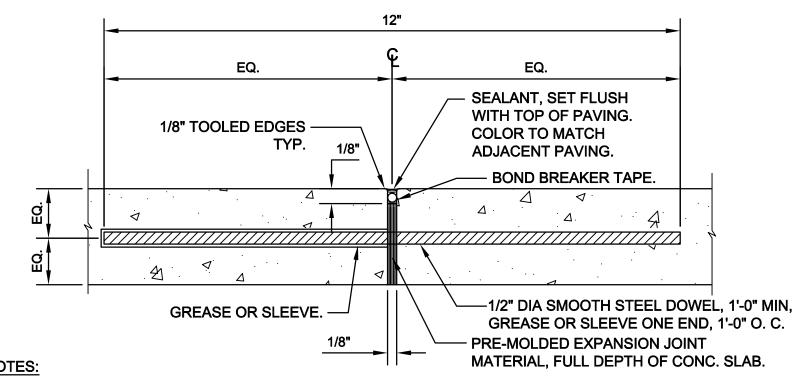

**EXPANSION JOINT SECTION** 

# **CONCRETE JOINT NOTES:**

Plot Date: 10 July 2013 - 4:18 PM

Plotted by: Jakob Schillinger

- 1. LOCATE EXPANSION JOINTS AT INTERVALS OF 20 FEET.
- 2. LOCATE TOOLED SCORE JOINT SECTIONS AT INTERVALS OF 4 FEET. — TOOLED EDGES.

### **TOOLED SCORE JOINT SECTION**

# TYPICAL CONCRETE JOINT DETAIL SCALE: NTS

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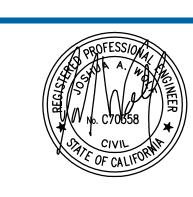
PAVEMENT -

2 SACK SLURRY

BACKFILL

PIPE OD

PEA GRAVEL COVER



SCALE: NTS

**TYPICAL STORM DRAIN &** 



SEE STANDARD PIPE TRENCH WIDTH @ RIGHT

**IRRIGATION SLEEVE TRENCH DETAIL** 



IMPORT TOPSOIL

COMPACTED TO

3" MIN. UNDER PIPE BELL

FULL WIDTH OF TRENCH

TRENCH STABILIZATION MATERIAL (WHEN REQ'D)

95% RELATIVE

COMPACTION

PIPE DIA | MINIMUM | MAXIMUM | "A" | "A"

6"

12"

14"


< 4"

4" TO 6"

6" TO 15"

- CLASS 2 AGGREGATE

BASE

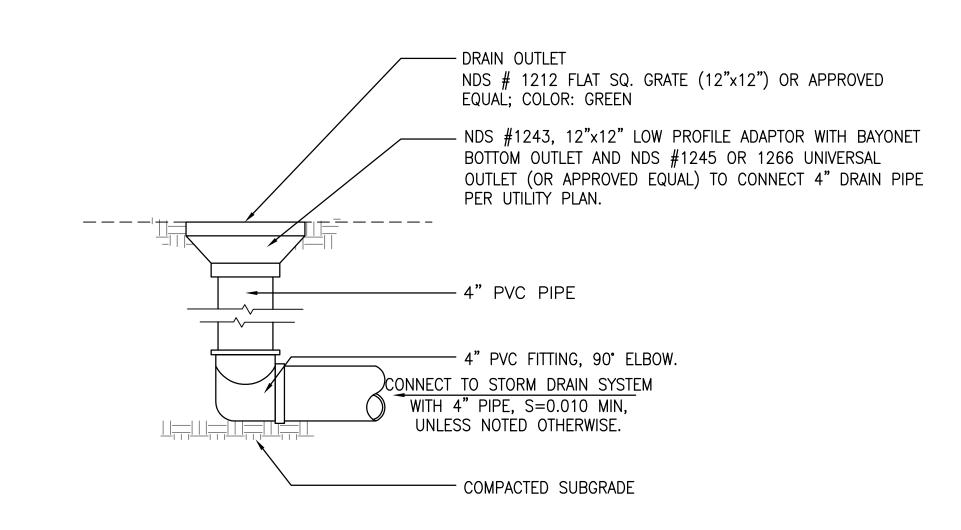



**KARUK TRIBE** Drawn JS Designer JS KCDC/KTHA PARKING LOT IMPROVEMENTS Drafting JW Check **CONSTRUCTION DETAILS** Approved


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> Drawing No: C-501

7/10/13

Scale AS SHOWN

Sht 10 of 13 Rev:

Cad File No: G:\01257 Karuk Tribe\01257-12-001 On-Call Eng Services\06-CAD\KCDC-KTHA\Sheets\0125712001-10-13-C-501-C-503-DETAILS-KTHA.dwg

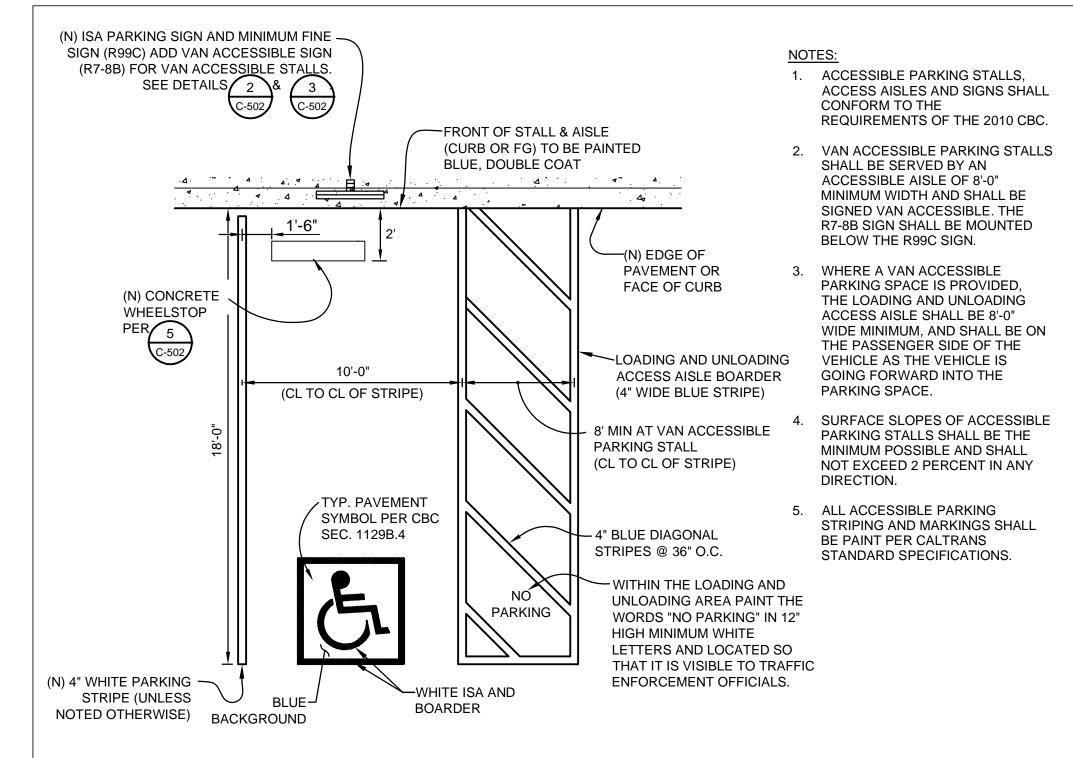



ACCESSIBLE


VAN ACCESSIBLE SIGN R7-8B

- 1. ACCESSIBLE PARKING SIGNS SHALL CONFORM TO THE REQUIREMENTS OF CBC SEC. 1129B.4 AND THE DETAILS SHOWN ON THIS DRAWING.
- 2. THE BOTTOM OF THE SIGN OR PLAQUE PANEL SHALL BE A MINIMUM OF 7'-0" ABOVE THE SURROUNDING SURFACE.
- 3. SIGN PANELS SHALL BE REFLECTORIZED, 16 GA MIN GALV STL WITH PORCELAIN ENAMEL FINISH AND WHITE LETTERS/SYMBOLS ON A BLUE BACKGROUND . THE BLUE COLOR SHALL BE EQUAL TO COLOR NO. 15090 IN FEDERAL STANDARD 595A.

STANDARD ACCESSIBLE PARKING SIGNS

4. INSTALL SIGNS ON POST PER  $\left(\frac{3}{C-502}\right)$ 

SCALE: NTS

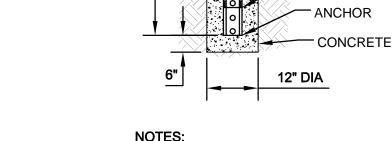

1. POST, SLEEVE AND ANCHOR SHALL BE 12 GAUGE HOT DIPPED GALVANIZED STEEL CONFORMING TO ASTM A653 DES. G90.

- 2. THE BOTTOM OF THE SIGN OR PLAQUE PANEL SHALL BE A MINIMUM OF 7'-0" ABOVE THE SURROUNDING SURFACE
- 3. ALL SIGN PANELS SHALL BE MOUNTED AS DIRECTED IN THE ENGINEER IN THE FIELD.



SIGN PER

PLAN

TYPICAL SIGN POST

-SLEEVE

5/16" GALV. OR ALUMINUM ALLOY -

WASHER

FACE SIGN -

\_\_\_\_

\_3/8" X 7/16" DRIVE

—ANCHOR SLEEVE 21/2"

-ANCHOR 21/4 X

21/4", 36" DEEP

—SIGN POST 2" X

2", 12" DEEP

3/8" X 7/16" DRIVE


RIVET

X 2½", 18" DEEP

RIVET



SCALE: NTS

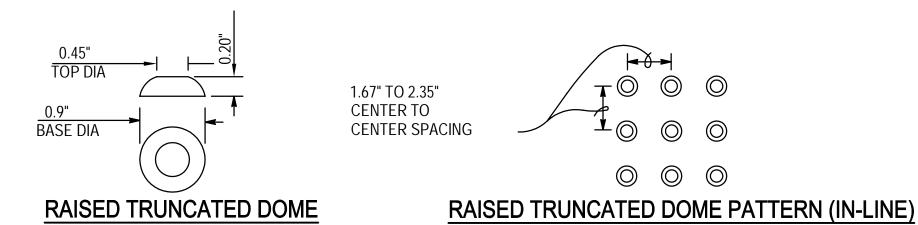

## NOTES:

Plot Date: 10 July 2013 - 4:18 PM


- 1. DETECTABLE WARNING SURFACE SHALL EXTEND THE FULL WIDTH AND 3'-0" DEPTH OF THE FLUSH
- 2. THE EDGE OF THE DETECTABLE WARNING SHALL BETWEEN 6" AND 8" AWAY FROM THE STREET GUTTER FLOWLINE.

TYPICAL VAN ACCESSIBLE PARKING STALL


DETECTABLE WARNING SHALL BE A PREFORMED MATERIAL AS APPROVED BY THE ENGINEER. THE USE OF CONCRETE STAMPING IS NOT PERMITTED. APPROVED DETECTABLE WARNING PRODUCTS ARE:

ARMORTILE CAST-IN-PLACE SYSTEM - BY ENGINEERED PLASTICS INC., 300 INTERNATIONAL DRIVE, SUITE 100, WILLIAMSVILLE, NY 14421 OR APPROVED EQUAL.

4. DETECTABLE WARNING SURFACE SHALL BE BRICK RED.

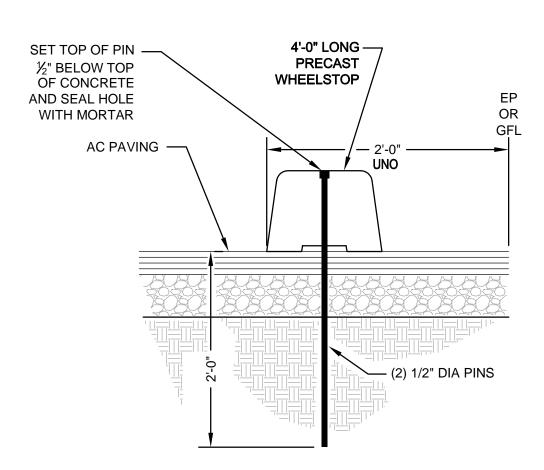

NOTE:
1. PRECAST WHEELSTOP TO BE JENSEN PRECAST S-48 OR APPROVED EQUAL

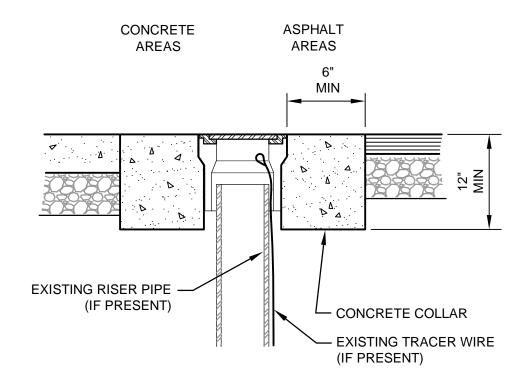

### NOTES:

- 1. THE CONTRACTOR SHALL COMPLETELY DEMOLISH EXISTING CONCRETE COLLAR (IF PRESENT) TO A DEPTH OF 12 INCHES.
- 2. ADJUSTED UTILITY COVER MAY BE POURED MONOLITHICALLY WITH NEW


TYPICAL ADJUST UTILITY COVER TO GRADE DETAIL

TYPICAL CONCRETE WHEELSTOP

SCALE: NTS

TYPICAL DETECTABLE WARNING SURFACE

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Drawn JS Designer JS Drafting JW Check Approved 7/10/13

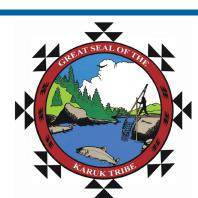AS SHOWN

**KARUK TRIBE** KCDC/KTHA PARKING LOT IMPROVEMENTS **CONSTRUCTION DETAILS** 

Contract No. 0125712001 This Drawing shall not be used | Original Size


Sht 11 of 13 for Construction unless Signed and Sealed For Construction

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Drawing No: C-502 Rev:


Drawn | Manager | Director |

ADJUST SCALES ACCORDINGLY

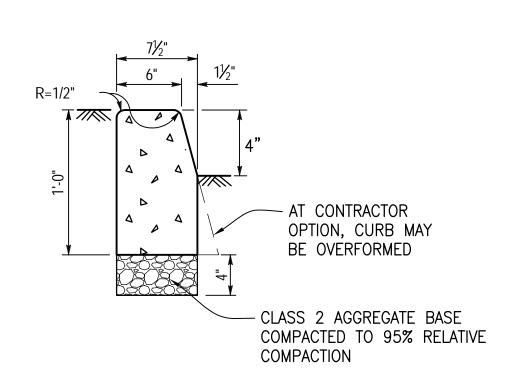

NOTE:
1. FINISH BACK SIDES OF CURBS WHERE EXPOSED.


1 TYPICAL VERTICAL CURB DETAIL
C-503 SCALE: NTS

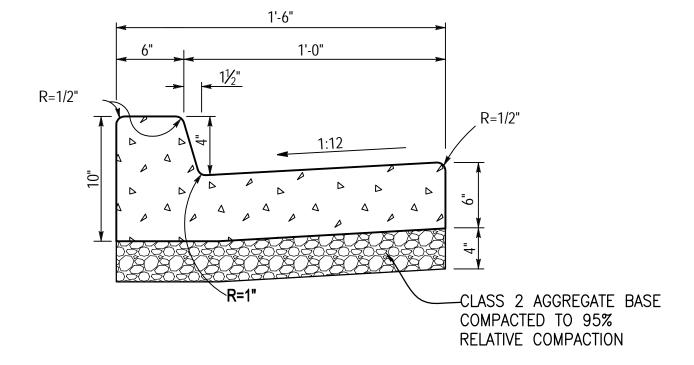

NOTE:

1. FINISH BACK SIDES OF CURBS WHERE EXPOSED.

2 TYPICAL CURB AND GUTTER
C-503 SCALE: NTS

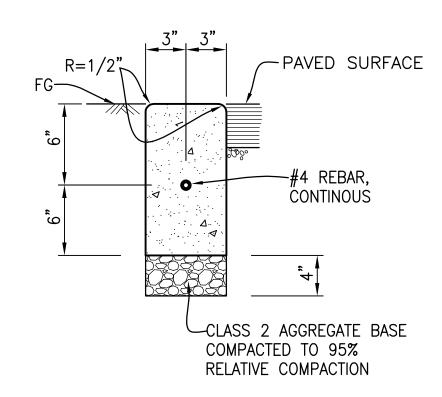

TYPICAL FLUSH CURB DETAIL

C-503 SCALE: NTS

VERTICAL CURB


HEIGHT PER PLAN

FLUSH CURB

OR FG

C-5033

TYPICAL CURB TRANSITION DETAIL

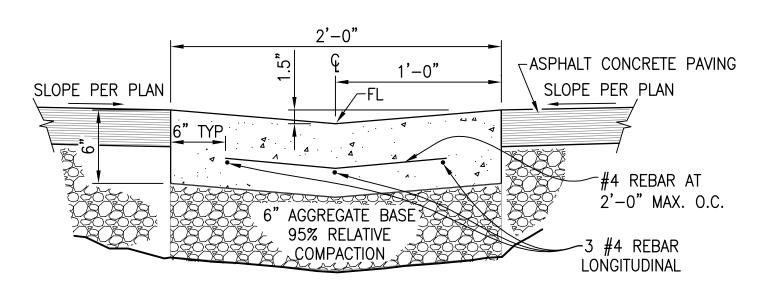


NOTE:

1. ASPHALT CONCRETE SHALL BE HELD 1/8" HIGH AT EDGE OF PORTLAND CEMENT CONCRETE.


TYPICAL CONCRETE VALLEY GUTTER

SCALE: NTS

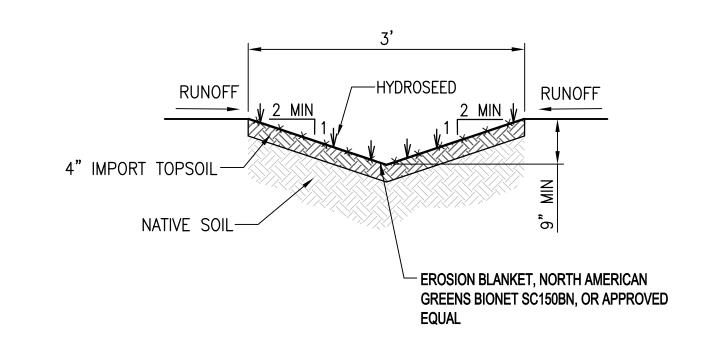

6 TYPICAL DRAINAGE SWALE

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						BAR IS ONE INCH ON ORIGINAL DRAWING
-	-	-			-	0 ■ 1"  IF NOT ONE INCH ON THIS SHEET.
No	Revision Note: * indicates signatures on original issue of drawing or last revision of drawing	Drawn	Job	Project	Date	ADJUST SCALES ACCORDINGLY

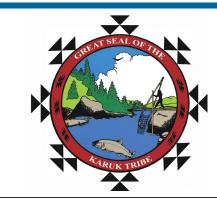







Drawn JS		Designer	Client Projec	
Drafting <sub>JW</sub> Check		Design Check	JW	Title
Approved	JW			
Date	7/10/13			Contra

Scale AS SHOWN


Client Project Title	KARUK TRIBE KCDC/KTHA PARKING LOT IMPROVEMENTS CONSTRUCTION DETAILS
Contract	No. 0125712001

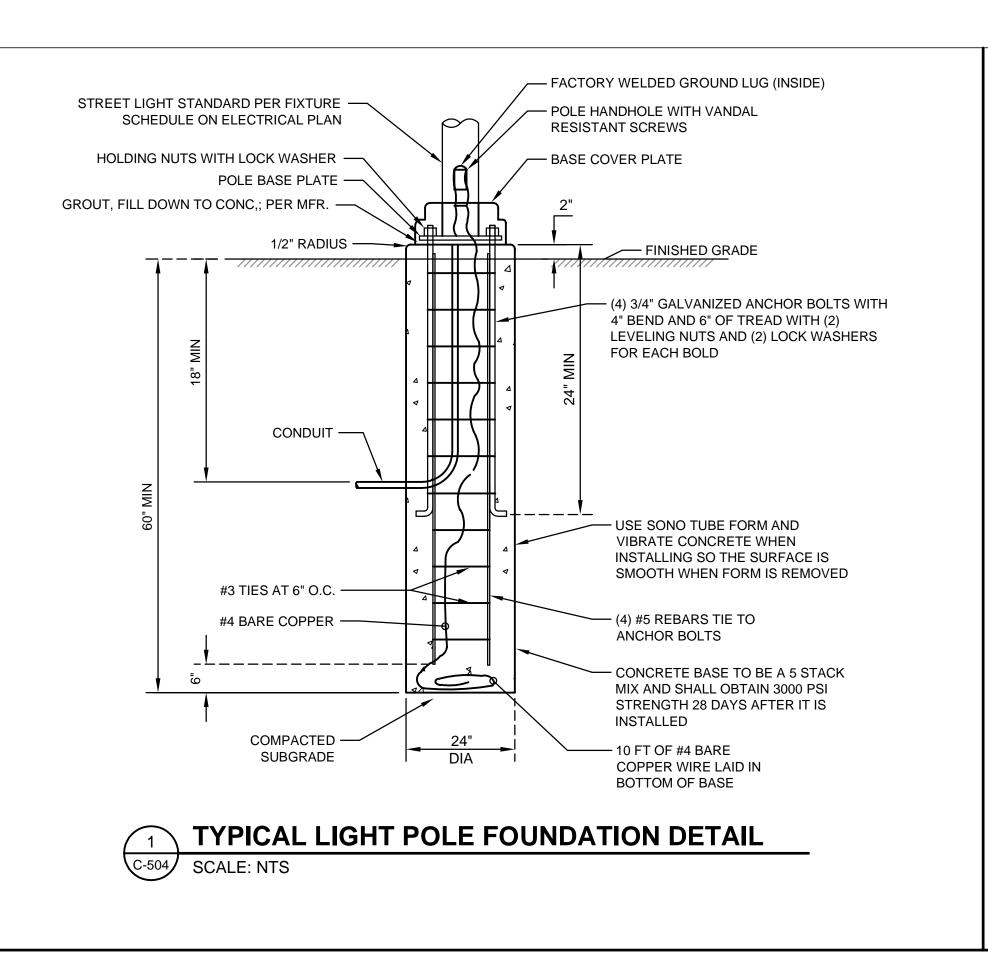


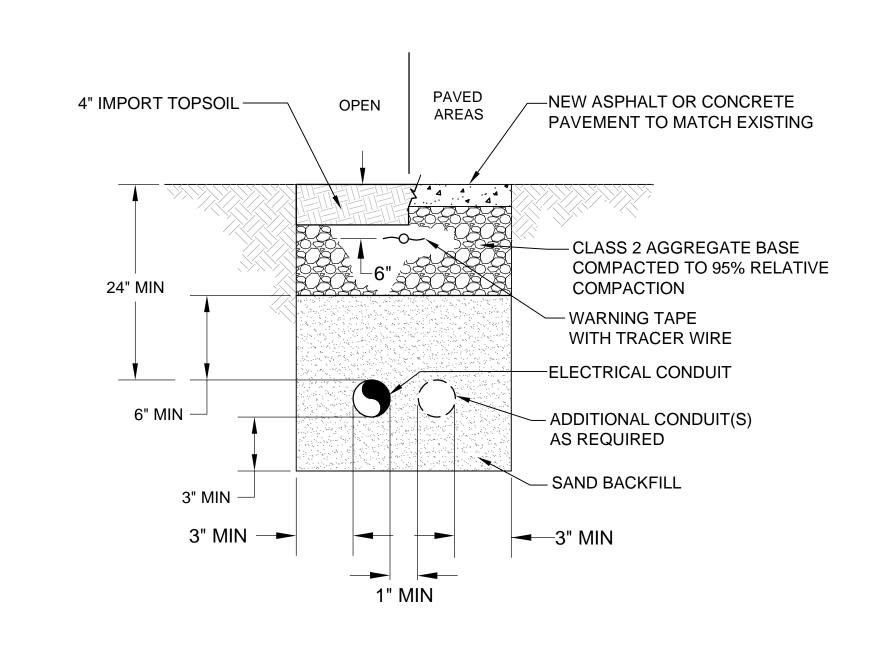

TYPICAL ELECTRICAL TRENCH


C-504 SCALE: NTS

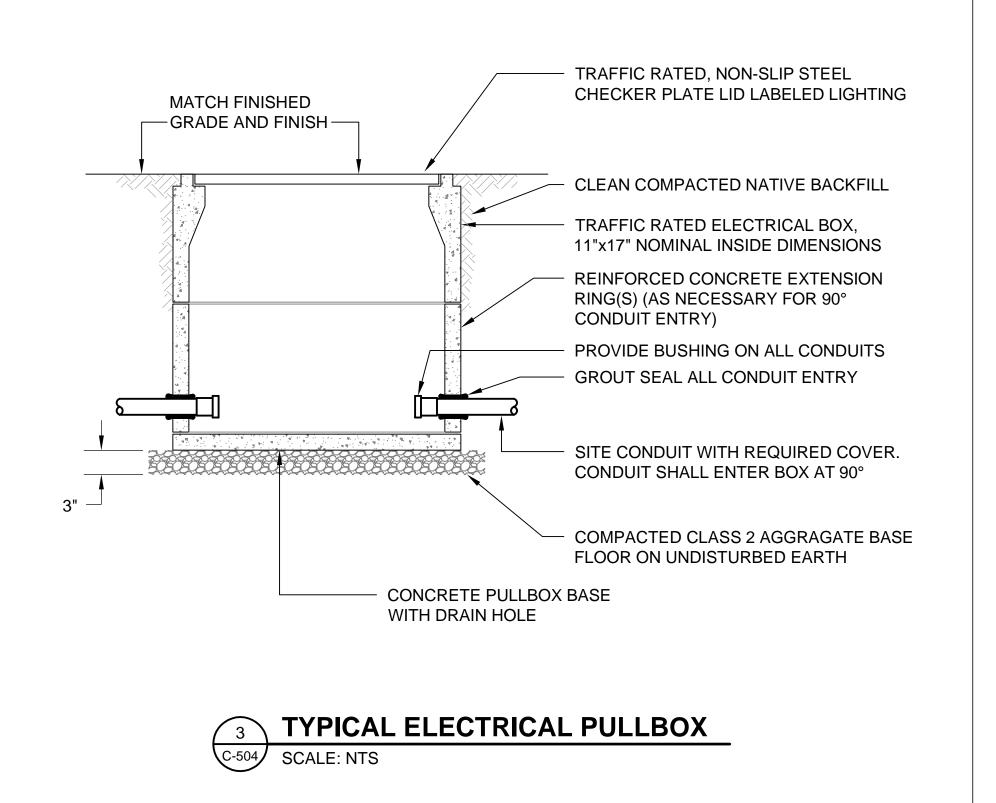

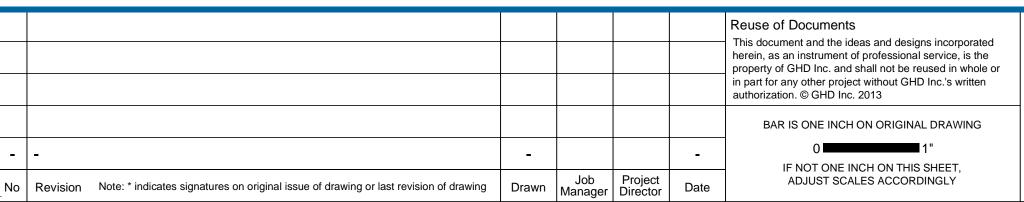

Plot Date: 10 July 2013 - 4:18 PM

Plotted by: Jakob Schillinger

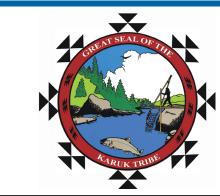





Drawn	JS	Designer	JS	l	KARUK TRII KCDC/KTHA	<del></del>
Drafting Check	JW	Design Check	JW		CONSTRUC	
Approved	JW 7/10/13			Contract N	No. 0125712001	
Scale	AS SHOWN	for Co	rawing shall not be used nstruction unless Signed ealed For Construction	Original Size	Drawing No:	C-504

**KARUK TRIBE** ject KCDC/KTHA PARKING LOT IMPROVEMENTS **CONSTRUCTION DETAILS** 

Sht 13 of 13