
Karuk Community Health Clinic

64236 Second Avenue
Post Office Box 316
Happy Camp, CA 96039
Phone: (530) 493-5257
Fax: (530) 493-5270

Karuk Tribe

**Administrative Office**

Phone: (530) 493-1600 • Fax: (530) 493-5322
64236 Second Avenue • Post Office Box 1016 • Happy Camp, CA 96039

Karuk Dental Clinic

64236 Second Avenue
Post Office Box 1016
Happy Camp, CA 96039
Phone: (530) 493-2201
Fax: (530) 493-5364

Request for Proposals

21-RFP-010

For More Information: Contact – Ryan Hammer (530) 598-8249 Email: rhammer@karuk.us

Recommended Site Visit: Contact Ryan Hammer to schedule

Proposal Deadline: February 5th, 2021 no later than 5:00 p.m. (PST)

The Karuk Tribe requests proposals for the following Scope of Work required for the design of additional space for the Anavkaam Center located at 64236 Second Ave. Happy Camp, Ca 96039. A preliminary design will be available to potential bidders for review and bidding purposes. The design of this project will include the renovation and addition specifications for the existing 3,200sqft structure as well as the 2,200sqft (approx.) of proposed additional office, training and restroom space located on the West side of the existing facility. The proposed addition will require a redesign of the surrounding parking lot, to maximize available parking and handicap accessibility, as well as a new outdoor pavilion/common area between the proposed addition and the existing Medical Billing modular. *Selected Contractor will be responsible for printed and digital copies of 60%, 90% and 100% design documents, including all specifications, schematics, schedules, cost estimates and pay application reviews necessary for the construction phase of this project.* Designs will follow all Fire codes and ADA requirements as well as Federal building codes, as this project is located on Tribal land.

Task One – Renovation Design

The basic design of the renovation is outlined in the preliminary drawings. This concept is specific to our vision of the finished product, but can change in the interest of efficiency and/or cost savings with Owner approval. The finishes, fixtures and equipment schedules will be approved by Tribal Representative(s).

Task Two – Addition Design

The basic design of the additional space, to be added to the existing structure, is outlined in the preliminary drawings. This concept is specific to our vision of the finished product, but can change in the interest of efficiency and/or cost savings during the design phase with Owner approval. The finishes, fixtures and equipment schedules will be approved by Tribal Representative(s). Sound dampening material will be used in the walls that separate the existing facility from the addition.

Task Three – Parking lot and Outdoor pavilion design

The basic design of the renovation is outlined in the preliminary drawings. This concept is specific to our vision of the finished product, but can change in the interest of efficiency and/or cost savings with Owner approval. The finishes, fixtures and equipment schedules will be approved by Tribal Representative(s). The Civil portion of the design will include grade elevations with drainage, fencing and underground utility connections.

Responses to this Request for Proposals should include the following:

- 1) A statement of qualifications, including relevant project history.
- 2) A proposed approach and rationale for completion of the contract tasks described above, including descriptions of similar work previously completed and the results/benefits achieved.
- 3) A lump sum price, with attached price break-down page.
- 4) Names and telephone numbers of three client references.

**Responses must be hand, mail, or email delivered by Friday February 5th, 2021 no later than 5:00 p.m. (PST)
to:**

Emma Lee Perez, Contract Compliance Specialist
Karuk Tribe – Administration Office
64236 Second Avenue
P.O. Box 1016
Happy Camp, CA 96039
Faxes will not be accepted
Emails will be accepted at: emmaleeperez@karuk.us

Price Page for 21-RFP-010:

Proposal Submitted by:

Name: _____ **Phone Number:** _____

E-mail: _____ **Fax Number:** _____

Amount requested to be compensated for each task:

- Task: _____
- Task: _____
- Task: _____

List previous experience:

List up to three references with phone numbers below:

- 1) _____
- 2) _____
- 3) _____

Other Comments:

Indian Preference will apply in the selection process in accordance with the Indian Preference Act of 1934 (Title 25, USC, Section 47) and/or the Tribal Employment Rights Ordinance (TERO), based on funding source requirements.

All contracts that exceed \$2,500.00 shall be subject to a two percent (2%) Tribal Employment Rights Fee in accordance with the TERO Ordinance.

If applicable, construction contracts in excess of \$2,000, when required by Federal grant program legislation, are subject to compliance with the Davis-Bacon Act (40 USC 276a to a-7) as supplemented by Department of Labor regulations (29 CFR part 5).

PROPOSED RENOVATION AND ADDITION FOR:

KARUK TRIBE "OLD GYM" BUILDING

64236 SECOND AVE
HAPPY CAMP, CA 96039

PROJECT NUMBER: 19-3410

PROJECT TEAM

OWNER: THE KARUK TRIBE
64236 SECOND AVE
HAPPY CAMP, CA 96039

ARCHITECT: C&S DESIGN & ENGINEERING, INC.
2023 6th STREET WEST
ASHLAND, WI 54806
P: 715-682-0330

STRUCTURAL ENGINEER:

CONSULTANT: N/A

PLUMBING DESIGNER: N/A

HVAC ENGINEER: N/A

ELECTRICAL ENGINEER: N/A

SYMBOLS

- 1 KEY NOTE
- 3:12 ROOF SLOPE & DIRECTION
- H WINDOW TAG
- 100 DOOR TAG
- SLOPE: SLOPE OF SLAB
- A # A/B C INTERIOR ELEVATION TAG
- +1" STEP/ELEVATION CHANGE
- T.O. SLAB 106'-0" ELEVATION MARKER
- A WALL TYPE (SEE PLAN OR LEGEND FOR ADD. INFO)
- 4 12 ROOF SLOPE
- 1.0 GRID LINE
- 1 A200 BUILDING ELEVATION
- 1 A300 BUILDING SECTION
- 1 A401 WALL SECTION
- 1 A400 DETAIL/ENLARGED PLAN CALLOUT
- 1 A500 DETAIL CALLOUT

PROJECT DATA

PROJECT DATA

GENERAL NOTES

1. THE CONTRACTORS ARE TO KEEP A SET OF STATE APPROVED PLANS AT THE JOB SITE AT ALL TIMES.
2. A PRE-CONSTRUCTION CONFERENCE WILL BE HELD WITH THE CONTRACTORS BEFORE ANY WORK COMMENCES.
3. ALL WORK IS TO BE PERFORMED IN ACCORDANCE WITH THE STATE BUILDING, PLUMBING, ELECTRICAL, AND HVAC CODE CURRENTLY IN EFFECT.
4. ALL STATE AND LOCAL BUILDING PERMITS WILL BE OBTAINED BY THE OWNER AND MUST BE POSTED AT THE JOB SITE BY THE CONTRACTOR, U.N.O.
5. THE GENERAL CONTRACTOR IS RESPONSIBLE FOR CHECKING ALL CONTRACT DOCUMENTS FOR THEIR ACCURACY AND CONFIRMING THAT WORK IS BUILDABLE AS SHOWN BEFORE PROCEEDING WITH CONSTRUCTION. IF THERE ARE ANY QUESTIONS REGARDING THESE, OR OTHER COORDINATION QUESTIONS, THE CONTRACTOR IS RESPONSIBLE FOR OBTAINING CLARIFICATION FROM THE ARCHITECT BEFORE PROCEEDING WITH THE WORK IN QUESTION OR RELATED WORK.
6. THE OWNER SHALL INDEMNIFY AND HOLD HARMLESS THE DESIGN PROFESSIONAL FROM ANY CLAIM OR SUIT WHATSOEVER ARISING FROM, OR ALLEGED TO HAVE ARISEN FROM, THE CONTRACTOR'S PERFORMANCE OR THE FAILURE OF THE CONTRACTOR'S WORK TO CONFORM TO THE DESIGN INTENT OF THE CONTRACT DOCUMENTS.
7. THE WORK UNDER THE CONTRACT SHALL INCLUDE ALL LABOR, MATERIALS, TOOLS, FEES, INSURANCE, TAXES, ETC. FOR GENERAL CONSTRUCTION, INCLUDING MECHANICAL, PLUMBING AND ELECTRICAL CONSTRUCTION, AS APPLICABLE, FOR THE COMPLETE CONSTRUCTION OF THIS PROJECT.
8. ALL PRODUCTS AND MANUFACTURERS OF MATERIALS/FINISHES/ETC PER ARCHITECTURAL DRAWINGS OR SPECIFICATION. SUBSTITUTIONS OF EQUAL QUALITY AND PERFORMANCE PERMITTED AS APPROVED BY DESIGN PROFESSIONAL IN CHARGE.
9. ALL MATERIALS, SUPPLIES, AND EQUIPMENT SHALL BE INSTALLED AS PER MANUF. SPECIFICATIONS AND AS PER LOCAL CODES AND REQUIREMENTS. LOCATED PER PLAN.
10. THE CONTRACTOR MUST VERIFY ALL EXISTING CONDITIONS AT THE JOB SITE.
11. THE DESIGN PROFESSIONAL WILL NOT HAVE CONTROL OVER, OR CHARGE OF, AND WILL NOT BE RESPONSIBLE FOR THE CONSTRUCTION MEANS, METHODS, SEQUENCE OR PROCEDURES IN REGARDS TO THE MANNER IN WHICH THE STRUCTURE IS BUILT.
12. ALL PROPERTY LINES ARE ASSUMED UNLESS A CERTIFIED SURVEY MAP HAS BEEN PROVIDED FOR THE PROPERTY.
13. ALL BUILDING SETBACKS ARE MEASURED FROM THE EAVE LINE OF THE BUILDING.
14. THE CONTRACTOR IS TO HAVE ALL THE UTILITY LINES VERIFIED BY THE APPROPRIATE UTILITY LOCATING SERVICE. THE CONTRACTOR SHALL BE RESPONSIBLE TO HAVE A LOCATE DONE PRIOR TO BREAKING OF GROUND.
15. THE CONTRACTOR SHALL BE AWARE OF ALL PRIVATE UTILITIES LOCATIONS SUCH AS WATER, SEWER, AND GAS.
16. ALL DAMAGE TO EXISTING DRIVEWAYS, ROADWAYS, STREETS, CONCRETE SIDEWALKS, LAWNS, ETC. MUST BE RESTORED TO THE CONDITION THEY WERE BEFORE CONSTRUCTION COMMENCED.
17. PROVIDE A MINIMUM OF 2% DRAINAGE SLOPE AWAY FROM THE ENTIRE PERIMETER OF THE BUILDING FOR THE FIRST 20 FEET, U.N.O.
18. THE GENERAL CONTRACTOR SHALL BE SOLELY RESPONSIBLE FOR THE DESIGN, ADEQUACY, AND SAFETY OF ERECTING BRACING, SHORING AND TEMPORARY SUPPORTS, ETC. THE GENERAL CONTRACTOR IS RESPONSIBLE FOR THE STABILITY OF THE STRUCTURE PRIOR TO THE APPLICATION OF ALL SHEAR WALLS, ROOF SHEATHING, STRUCTURAL ELEMENTS AND FINISH MATERIALS.
19. THE GENERAL CONTRACTOR SHALL PERFORM HIGH QUALITY PROFESSIONAL WORK, JOIN MATERIALS TO UNIFORM ACCURATE FITS SO THAT THEY MEET WITH NEAT, STRAIGHT LINES, FREE OF SMEARS OR OVERLAPS, INSTALL EXPOSED MATERIALS APPROPRIATELY LEVEL, PLUMB AND AT ACCURATE RIGHT ANGLES OR FLUSH WITH ADJOINING MATERIALS. WORK OF EACH TRADE SHALL MEET ALL NATIONAL STANDARDS PUBLISHED BY THAT TRADE, EXCEPT IN THE CASE WHERE THE CONTRACT DOCUMENTS ARE MORE STRINGENT.
20. ALL EXISTING BUILDING DIMENSIONS MUST BE FIELD VERIFIED.
21. WRITTEN DIMENSIONS TO PREVAIL OVER SCALING OF DRAWINGS. CONTRACTOR(S) TO VERIFY ALL DIMENSIONS PRIOR TO CONSTRUCTION AND IMMEDIATELY NOTIFY DESIGNER OF ANY DISCREPANCIES.
22. ALL DIMENSIONS TO FACE OF STUD OR CONCRETE WALLS, U.N.O.
23. SEE SITE PLAN FOR NOTES AND DIMENSIONS NOT SHOWN.
24. SEE ELEVATIONS, INTERIOR ELEVATIONS AND FINISH SCHEDULE FOR MATERIALS NOT CALLED OUT.
25. IF APPLICABLE, THE FIRE RATINGS OF WALLS AND CEILINGS MUST BE MAINTAINED BEHIND ALL INSTALLED FIXTURES (BATH UNITS, VANITIES, CEILING FANS, ELECTRICAL BOXES, EXHAUST FANS, ETC).
26. THE CONTRACTOR SHALL TAKE ABSOLUTE CARE TO PROTECT NEWLY INSTALLED MATERIALS, MILLWORK, BUILT-INS AND FINISHES.
27. THE CONTRACTOR SHALL PROVIDE ALL OPERATING AND MAINTENANCE DATA AND ALL MANUFACTURER'S, INSTALLER'S AND APPLICATOR'S GUARANTEES, BONDS, WARRANTIES AND SERVICE INSTRUCTIONS.
28. CONFIRM WINDOW OR DOOR NUMBER WITH MFR. AND SITE CONDITIONS. ALL OPERABLE WINDOWS AND DOORS SHALL HAVE REMOVABLE SCREENS.
29. CONTRACTOR TO VERIFY R.O. REQUIREMENTS FOR WINDOWS & EXTERIOR DOORS WITH WINDOW MANUFACTURER PRIOR TO ORDERING
30. REFERENCE ELEVATIONS AND/OR BUILDING SECTIONS FOR WINDOW OPERATIONS
31. REFER TO ENGINEERED TRUSS DRAWINGS, IF APPLICABLE, FOR PLACEMENT OF TRUSS COMPONENTS. CONTRACTOR IS TO FIELD VERIFY ALL TRUSS DIMENSIONS BEFORE PRODUCTION OF TRUSSES.
32. ALL GAS PIPING INSTALLATIONS SHALL COMPLY WITH NFPA 54-2015, NATIONAL FUEL GAS CODE.

INDEX TO DRAWINGS

ATS	TITLE SHEET
AD100	AS-BUILT FLOOR PLAN
AD101	AS-BUILT ELEVATIONS
C100	NEW SITE PLAN
A100	NEW FLOOR PLAN
A200	NEW ELEVATIONS
A201	NEW ELEVATIONS
A300	NEW CROSS SECTION

PROPOSED RENOVATION AND ADDITION FOR:
KARUK TRIBE "OLD GYM" BUILDING
64236 SECOND AVE, HAPPY CAMP, CA 96039

TITLE PAGE

DESIGN & ENGINEERING with framework design inc
2023 6th Street West, Ashland, WI 54806
Telephone (715) 682-0330 www.csdengineering.com

DESIGNED:	L.D.
DRAWN:	A.D.E.
SCALE:	AS NOTED
DATE:	JANUARY 2020
PROJECT NO.	19-3410

REVISIONS:

APPROVED:


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SHEET NO. **ATS**


STANDARD ABBREVIATIONS

ABOVE FINISH FLOOR	A.F.F.	CONTRACTOR	CONTR.	FIRE EXTINGUISHER	F.E.	JANITOR	JAN.	OVERFLOW DRAIN	O.F.D.	STEEL	STL.
ACOUSTICAL CEILING TILE	ACT.	FIRE EXTINGUISHER CONTROL JOINT	C.J.	FIRE RATED	F.R.	JOINT	JST	PAINT	PT.	STORAGE	STOR.
ADDITIONAL	ADD.	COURSES	CRS.	FIXTURE	FX.	PAINTED	PTD.	STRUCTURAL	STR.	STRUCT	STRUC.
ADJUSTABLE	ADJ.	CUBIC FOOT (AGE)	CF	FLASHING	FLASHG	PANEL	PANL	SUSPEND (ED)	SUSP.	(D)	SUSP. (D)
ALIGN WITH BELOW	A.W.B.	DETAIL	DET.	FLOOR	FLR.	LAMINATED	LAM.	PARTITION	PTN.	TELEPHONE	TEL.
ALTERNATE	ALT.	DIAMETER	DIAM.	FLOOR PLAN	FLRG	LAVATORY	LAV.	PERFORATED	PERF.	THERMOPLASTIC POLYOLEFIN	TPO
ALUMINUM	ALLM.	DIMENSION	DISP	FOOTING	FTG.	LEVEL	LVL.	PLASTIC LAMINATE	PLAM.	THICKNESS	THK.
AMERICAN DISABILITIES ACT APPROXIMATELY	ADA	DISPENSER	DR	FOUNDATION	FDNT.	LIGHTING	LTG.	PLATE	PL.	TOP OF	T.O.
BASEMENT	BSMT.	DOWN	DN	FLUORESCENT	FLUR	LINE	LN.	POLYVINYL CHLORIDE	PVC	TOP OF CONCRETE	T.O.C.
BEAM	BM.	DOWNSPOUT	DS	GALVANIZED	GLV.	LONG LEG HORIZONTAL	LLH	POUNDS PER SQUARE INCH	PSI	TOP OF FOOTING	T.O.F.
BELOW	BELW.	DRAWING (S)	DWG. (S)	LOW POINT	LP.	LONG LEG VERTICAL	LLV	PRESERVATIVE TREATED PROPERTY	PROP.	TOP OF RAIL	T.O.R.
BITUMINOUS	BIT.	DRINKING FOUNTAIN	D.F.	MANUFACTURER	MFR.	QUANTITY	QTY.	QUARRY TILE	QT.	TOP OF STEEL	T.O.S.
BLOCK	BLK.	EACH	EA.	GLASS	GL.	MASONRY	MAS.	MASONRY OPENING	M.O.	TOP OF WALL	T.O.W.
BLOCKING BOARD	BLKG.	ELECTRICAL	ELEC.	GYPSUM	GYP.	MASONRY OPENING MATERIAL	MAT.	RADIUS	R.	TREAD	TRT.
BOTTOM	BOT.	ELEVATION	ELEV.	GYPSUM WALLBOARD	GYWB.	MECHANICAL	MCH.	REINFORCING	REINF.	TREATED	T.D.
BOTTOM OF BRICK COURSE	B.O.	ELEVATOR	EL.	HANDICAP ACCESSIBLE	H.C.	MEMBRANE	MEMB.	RESILIENT FLOORING	RESIL.	TRENCH DRAIN	TRD.
BUILDING	BLDG.	ENCLOSURE	ENCL.	HARDWARE	HW.	MINIMUM	MIN.	RETURN AIR	RA.	UNDERWRITERS	U.L.
BUILT-UP ROOFING	B.U.R.	EQUAL	EQ.	HEATING, VENTING, AND AIR CONDITIONING	HVAC	NOT APPLICABLE	N.A.	REVISION	REV.	UNLESS NOTED OTHERWISE	U.N.O.
CARPET	CPT.	EXISTING	EXST.	HEIGHT	HGT.	MISCELLANEOUS	MISC.	ROOF DRAIN	R.D.	VENEER PLASTER	V.P.
CAST-IN-PLACE	C.I.P.	EXPANSION	EXP.	HOLLOW CORE	H.C.	NON-COMBUSTIBLE	NC.	ROOM	RM.	VERIFY IN FIELD	V.I.F.
CAST IRON	C.I.	EXPANSION JOINT	E.J.	HOLLOW METAL	H.M.	NOT IN CONTRACT	N.I.C.	ROUGH OPENING	R.O.	VERT.	VERT.
CATCH BASIN	C.B.	EXTERIOR	EXT.	HORIZONTAL	HRZ.	NOT TO SCALE	N.T.S.	RUBBER	RUBR.	VINYL COMPOSITION TILE	VCT.
CEILING	CELG.	FACE OF CONCRETE	F.O.C.	HOUR	HR.	NUMBER	NO.	SECTION	SEC.	VINYL WALL COVERING	VWC.
CEMENT	CEM.	FACE OF FINISH	F.O.F.	INCANDESCENT	INCAN.	OCCUPANT / OCCUPANCY	OCC.	SHEET	SHT.	WATER CLOSET	W.C.
CENTER LINE	C.L.	FACE OF MASONRY	F.O.M.	INCH	IN.	ON CENTER	O.C.	SIMILAR	SIM.	WATERPROOFING	W.P.
CERAMIC TILE	C.T.	FACE OF FINISH	F.O.F.	INCLUDING	INCLD.	OPENING	OPNG.	SOLID CORE	S.C.	WELDED WIRE FABRIC	W.W.F.
CLEARANCE	CLR.	FINISH	FIN.	INSIDE DIAMETER	I.D.	OPPOSITE	OPP.	SQUARE	SQ.	WIDE FLANGE	W.F.
CLOSET	CLO.	FINISH FLOOR ELEVATION	F.F.E.	INSULATION	INS.	OPPOSITE HAND	O.H.	SQUARE FOOT (AGE)	SF	WINDOW	WDW.
COLUMN	COL.	FINISH GRADE	F.G.	INTERIOR	INT.	OUTSIDE DIAMETER	O.D.	STAINLESS STEEL	SS	WITHOUT	WO.
CONCRETE	CONC.	FINISH SURFACE	F.S.					STANDARD	STD.	WOOD	WD.

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AS-BUILT FLOOR PLAN

SCALE: 1/4" = 1'-0"

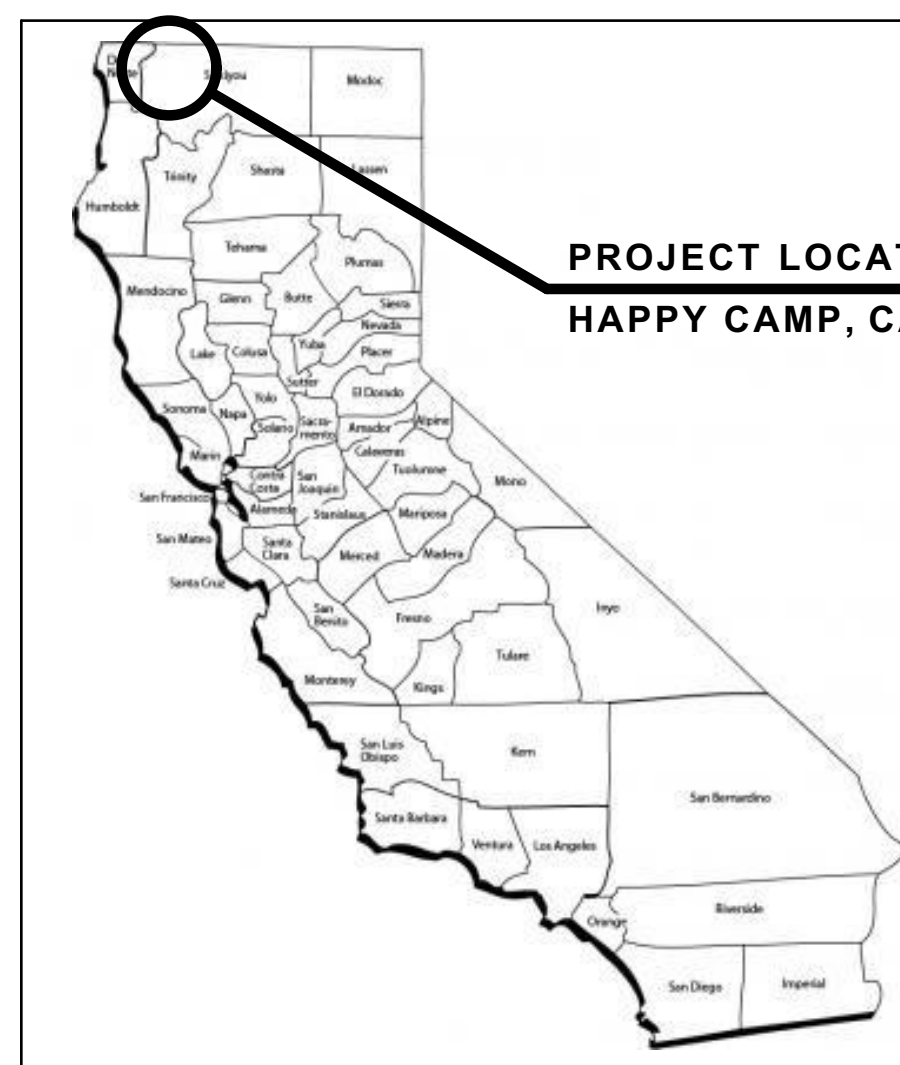PROPOSED RENOVATION AND ADDITION FOR:

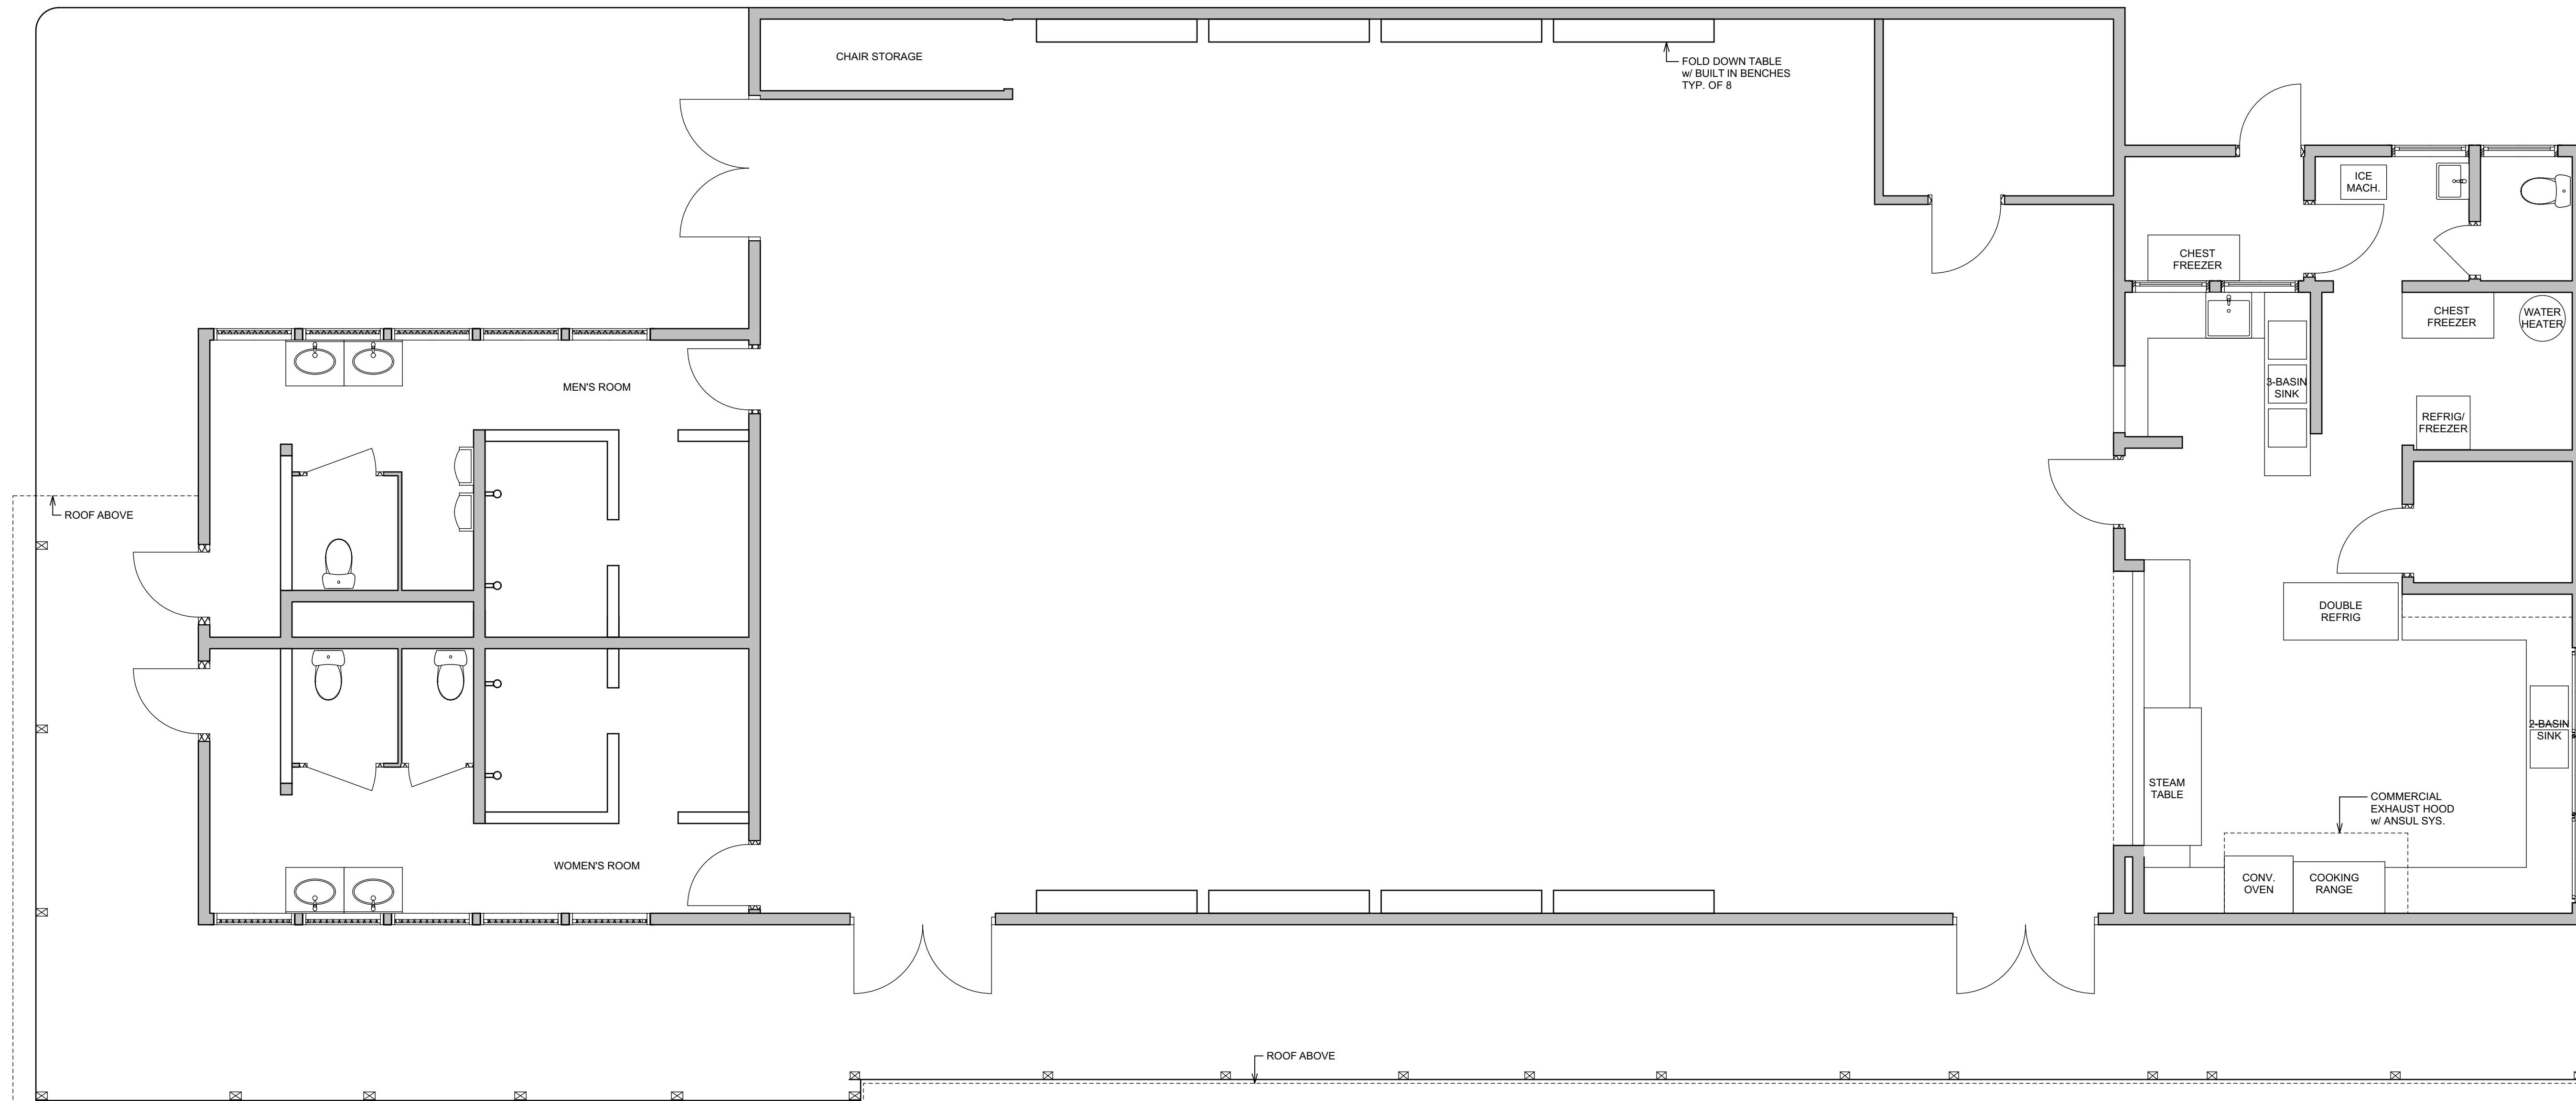KARUK TRIBE "OLD GYM" BUILDING

64236 SECOND AVE, HAPPY CAMP, CA 95039

AS-BUILT FLOOR PLAN


DESIGN & ENGINEERING
with framework design inc
2023 6th Street West, Ashland, WI 54806
Telephone (715) 682-0330 www.csdengineering.com

DESIGNED:	L.D.
DRAWN:	A.D.E.
SCALE:	AS NOTED
DATE:	JANUARY 2020
PROJECT NO.	19-3410

REVISIONS:


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AD100

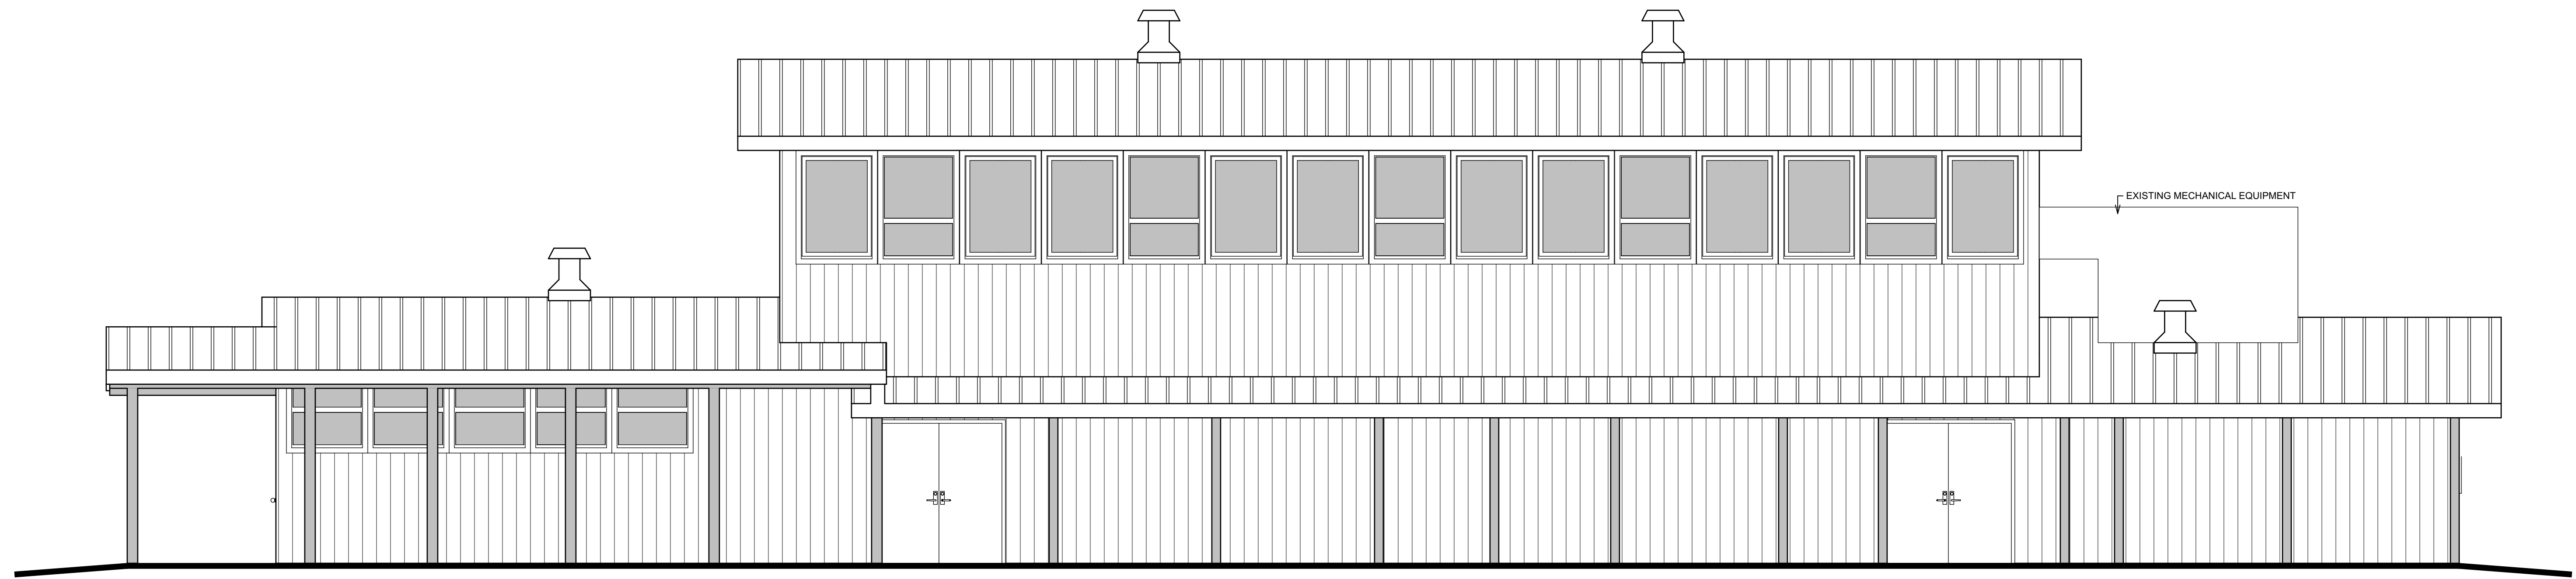


AS-BUILT EAST ELEVATION

SCALE: 1/4" = 1'-0"

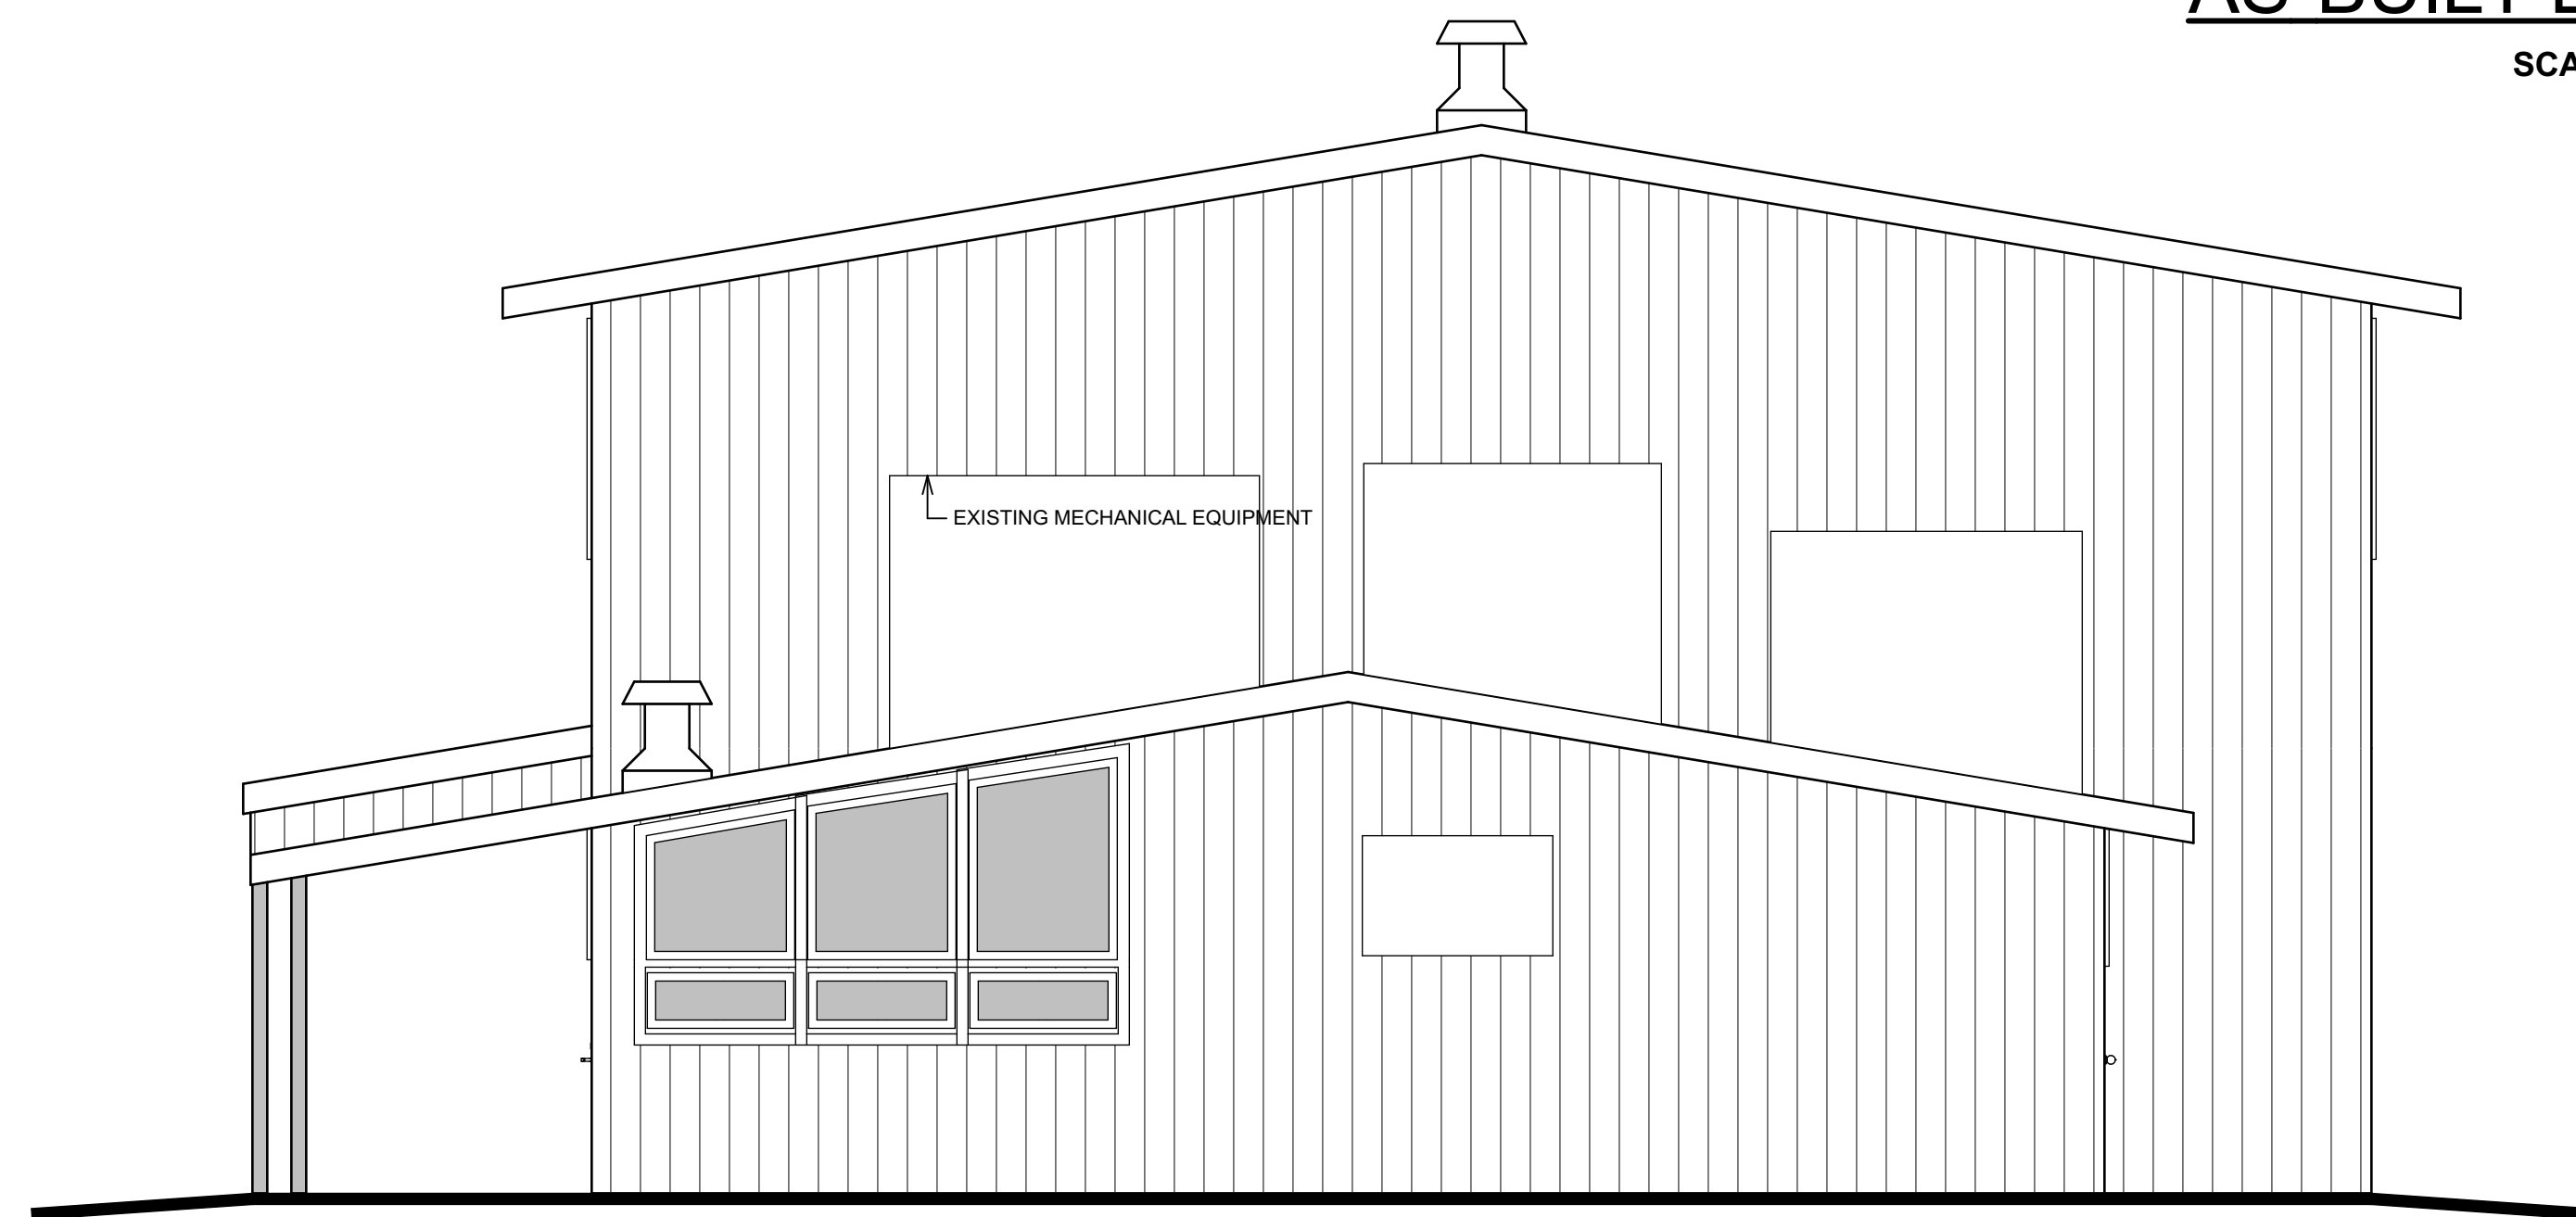


AS-BUILT NORTH ELEVATION

SCALE: 1/4" = 1'-0"

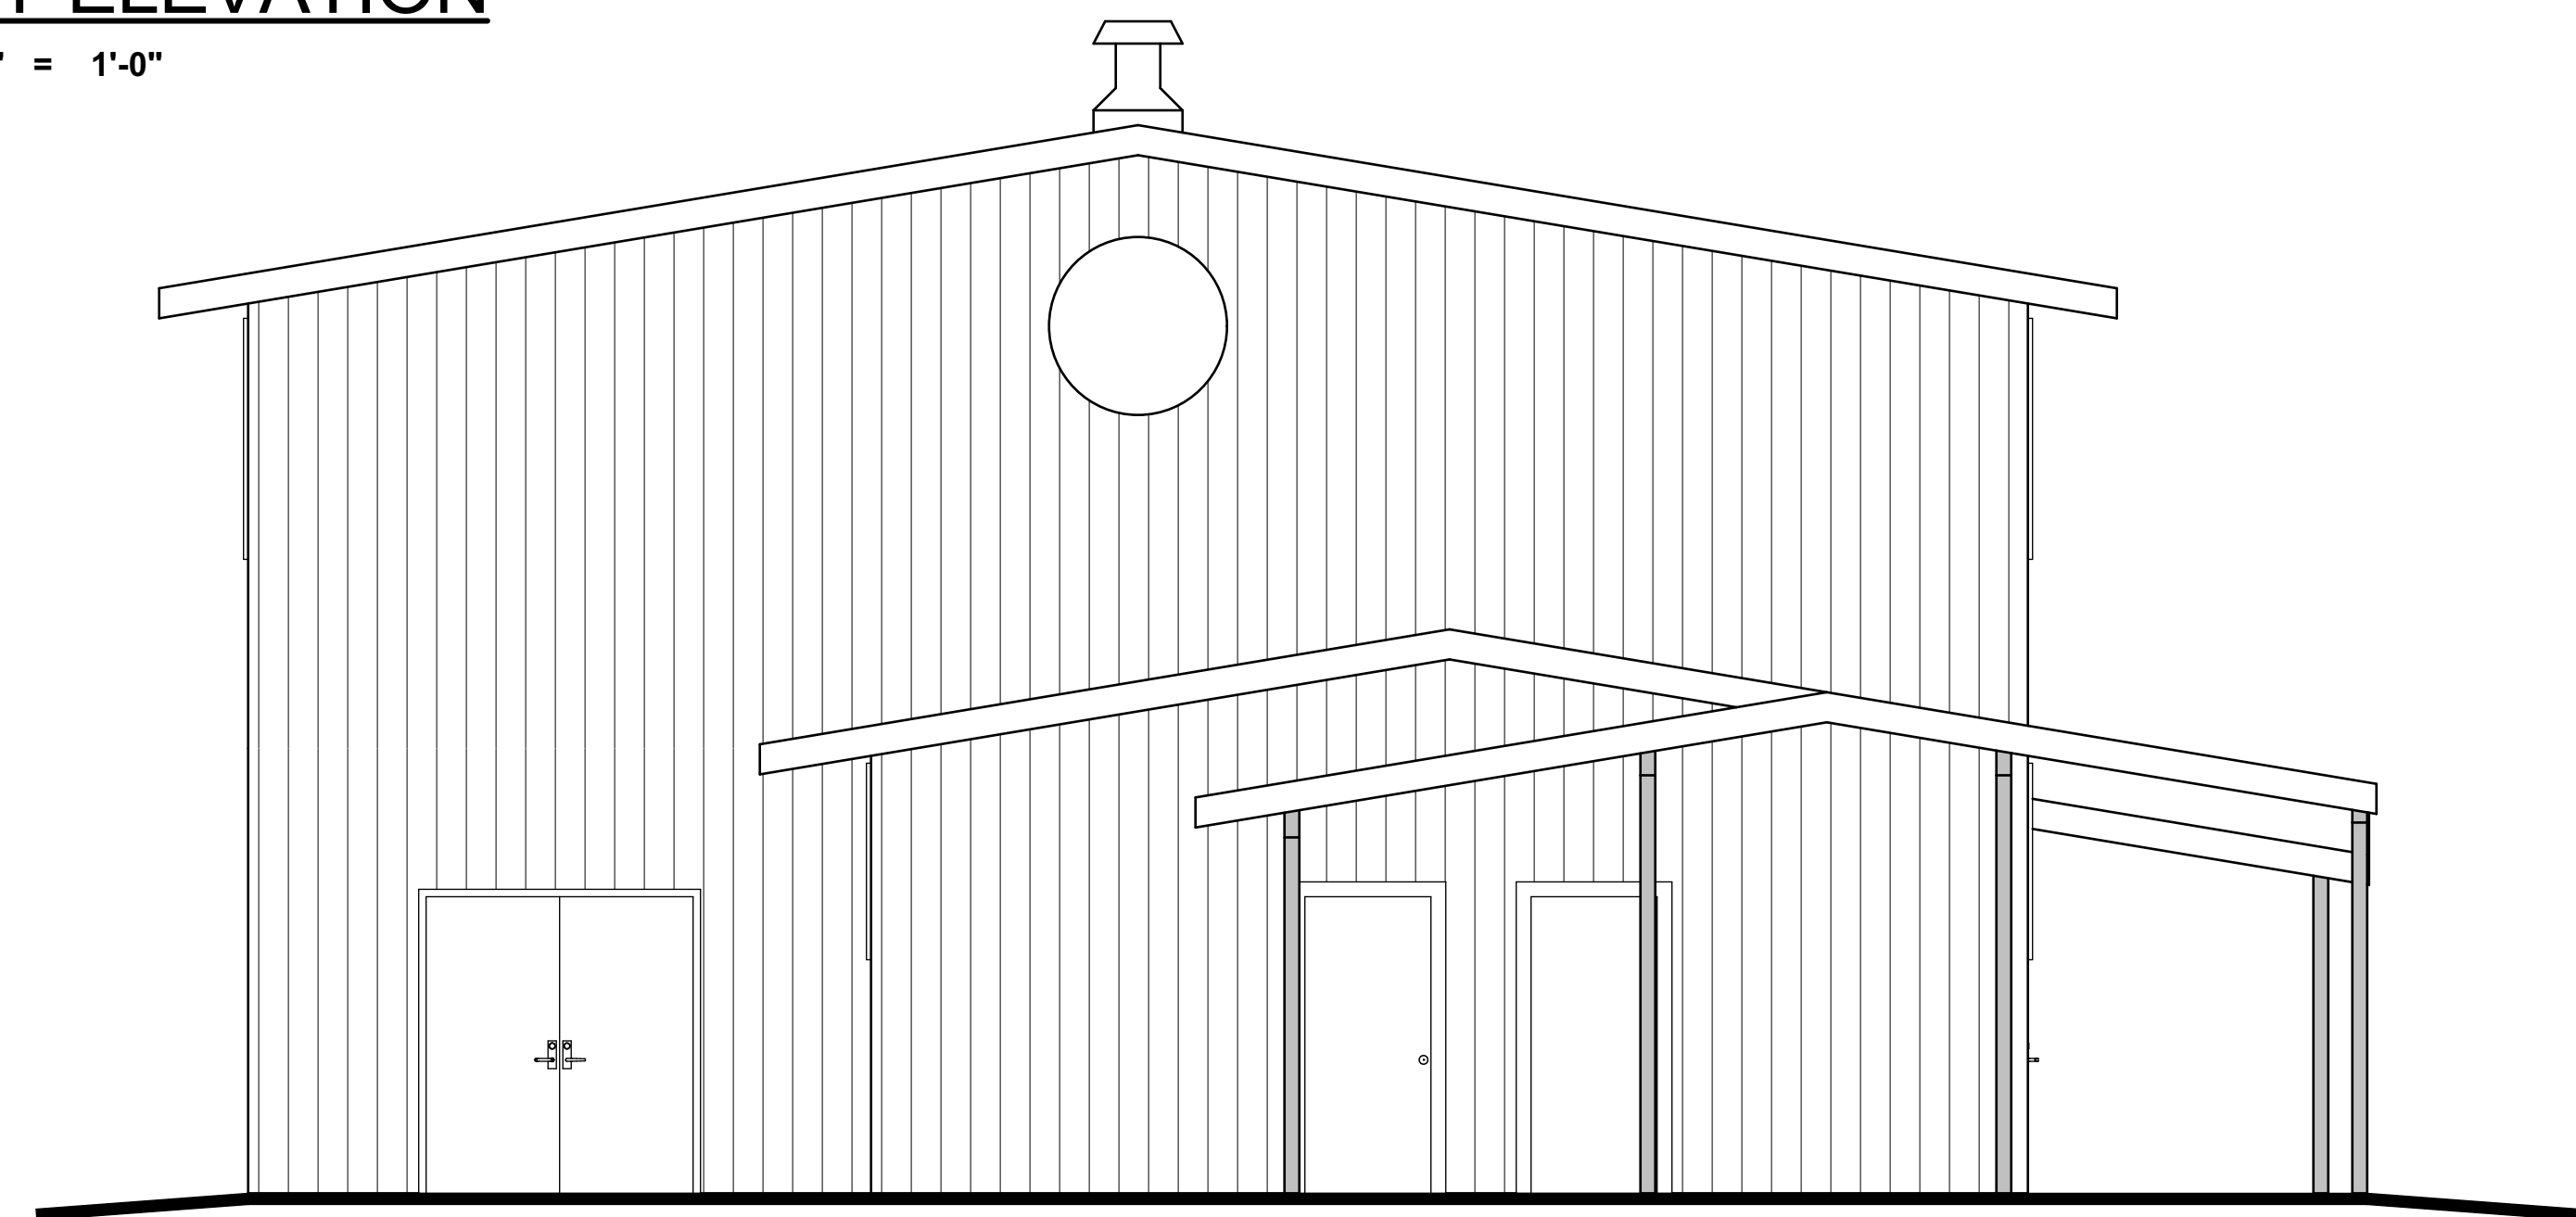

AS-BUILT SOUTH ELEVATIONS

SCALE: 1/4" = 1'-0"

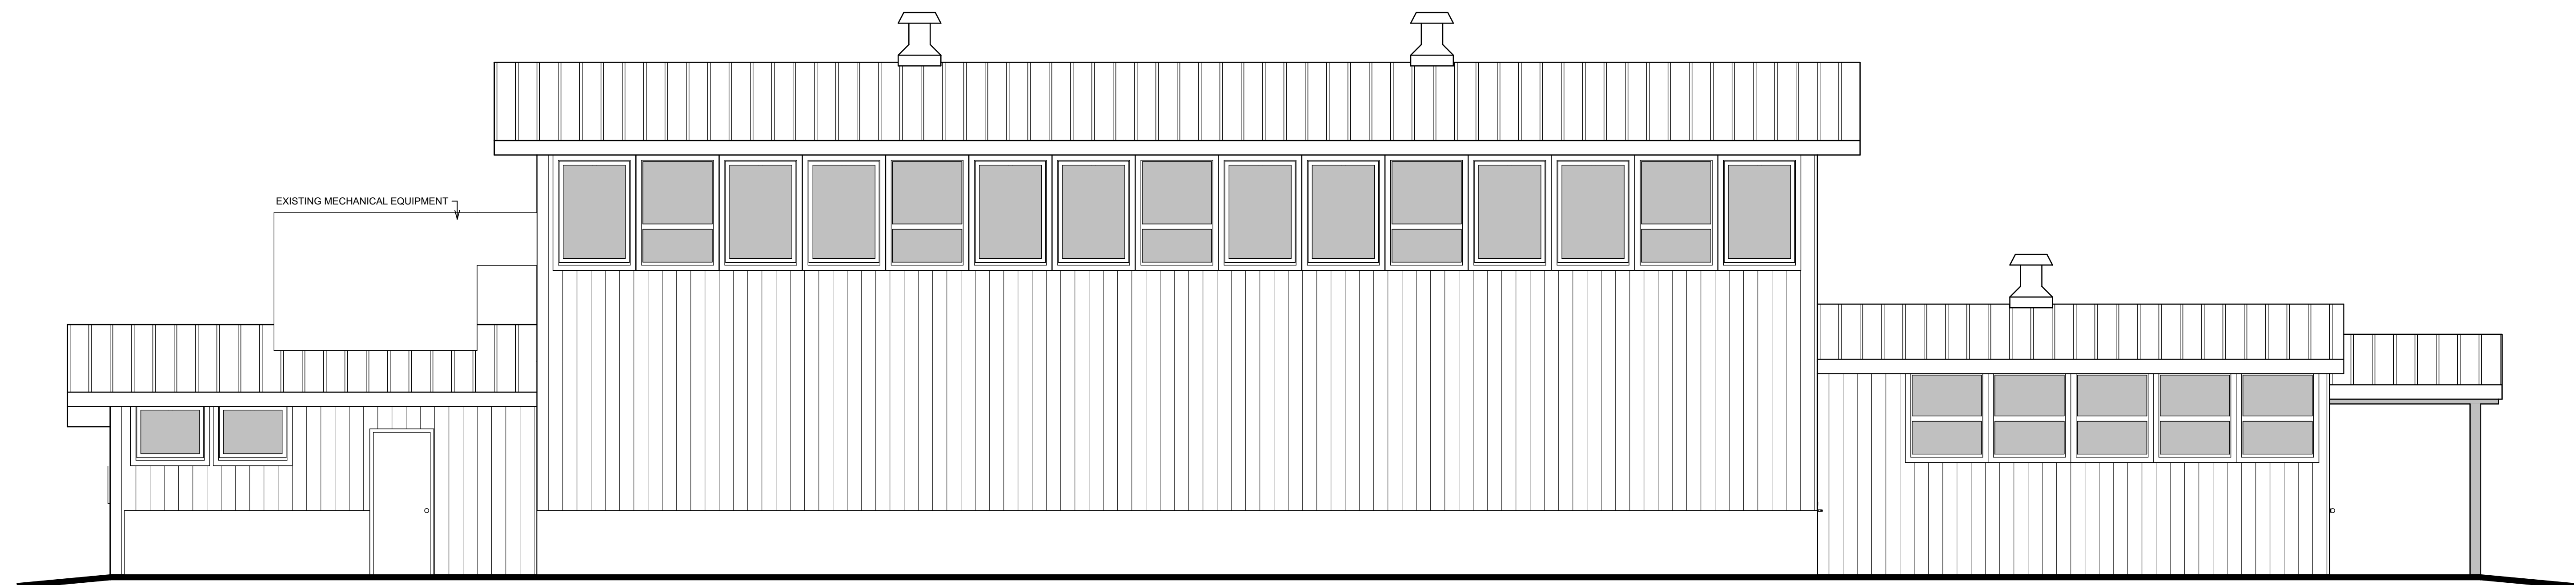

AS-BUILT WEST ELEVATION

SCALE: 1/4" = 1'-0"

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KARUK TRIBE "OLD GYM" BUILDING

64236 SECOND AVE, HAPPY CAMP, CA 96039

AS-BUILT ELEVATIONS

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19-3410


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SHEET NO.

AD101



NEW SITE PLAN

SCALE: 1" = 10'

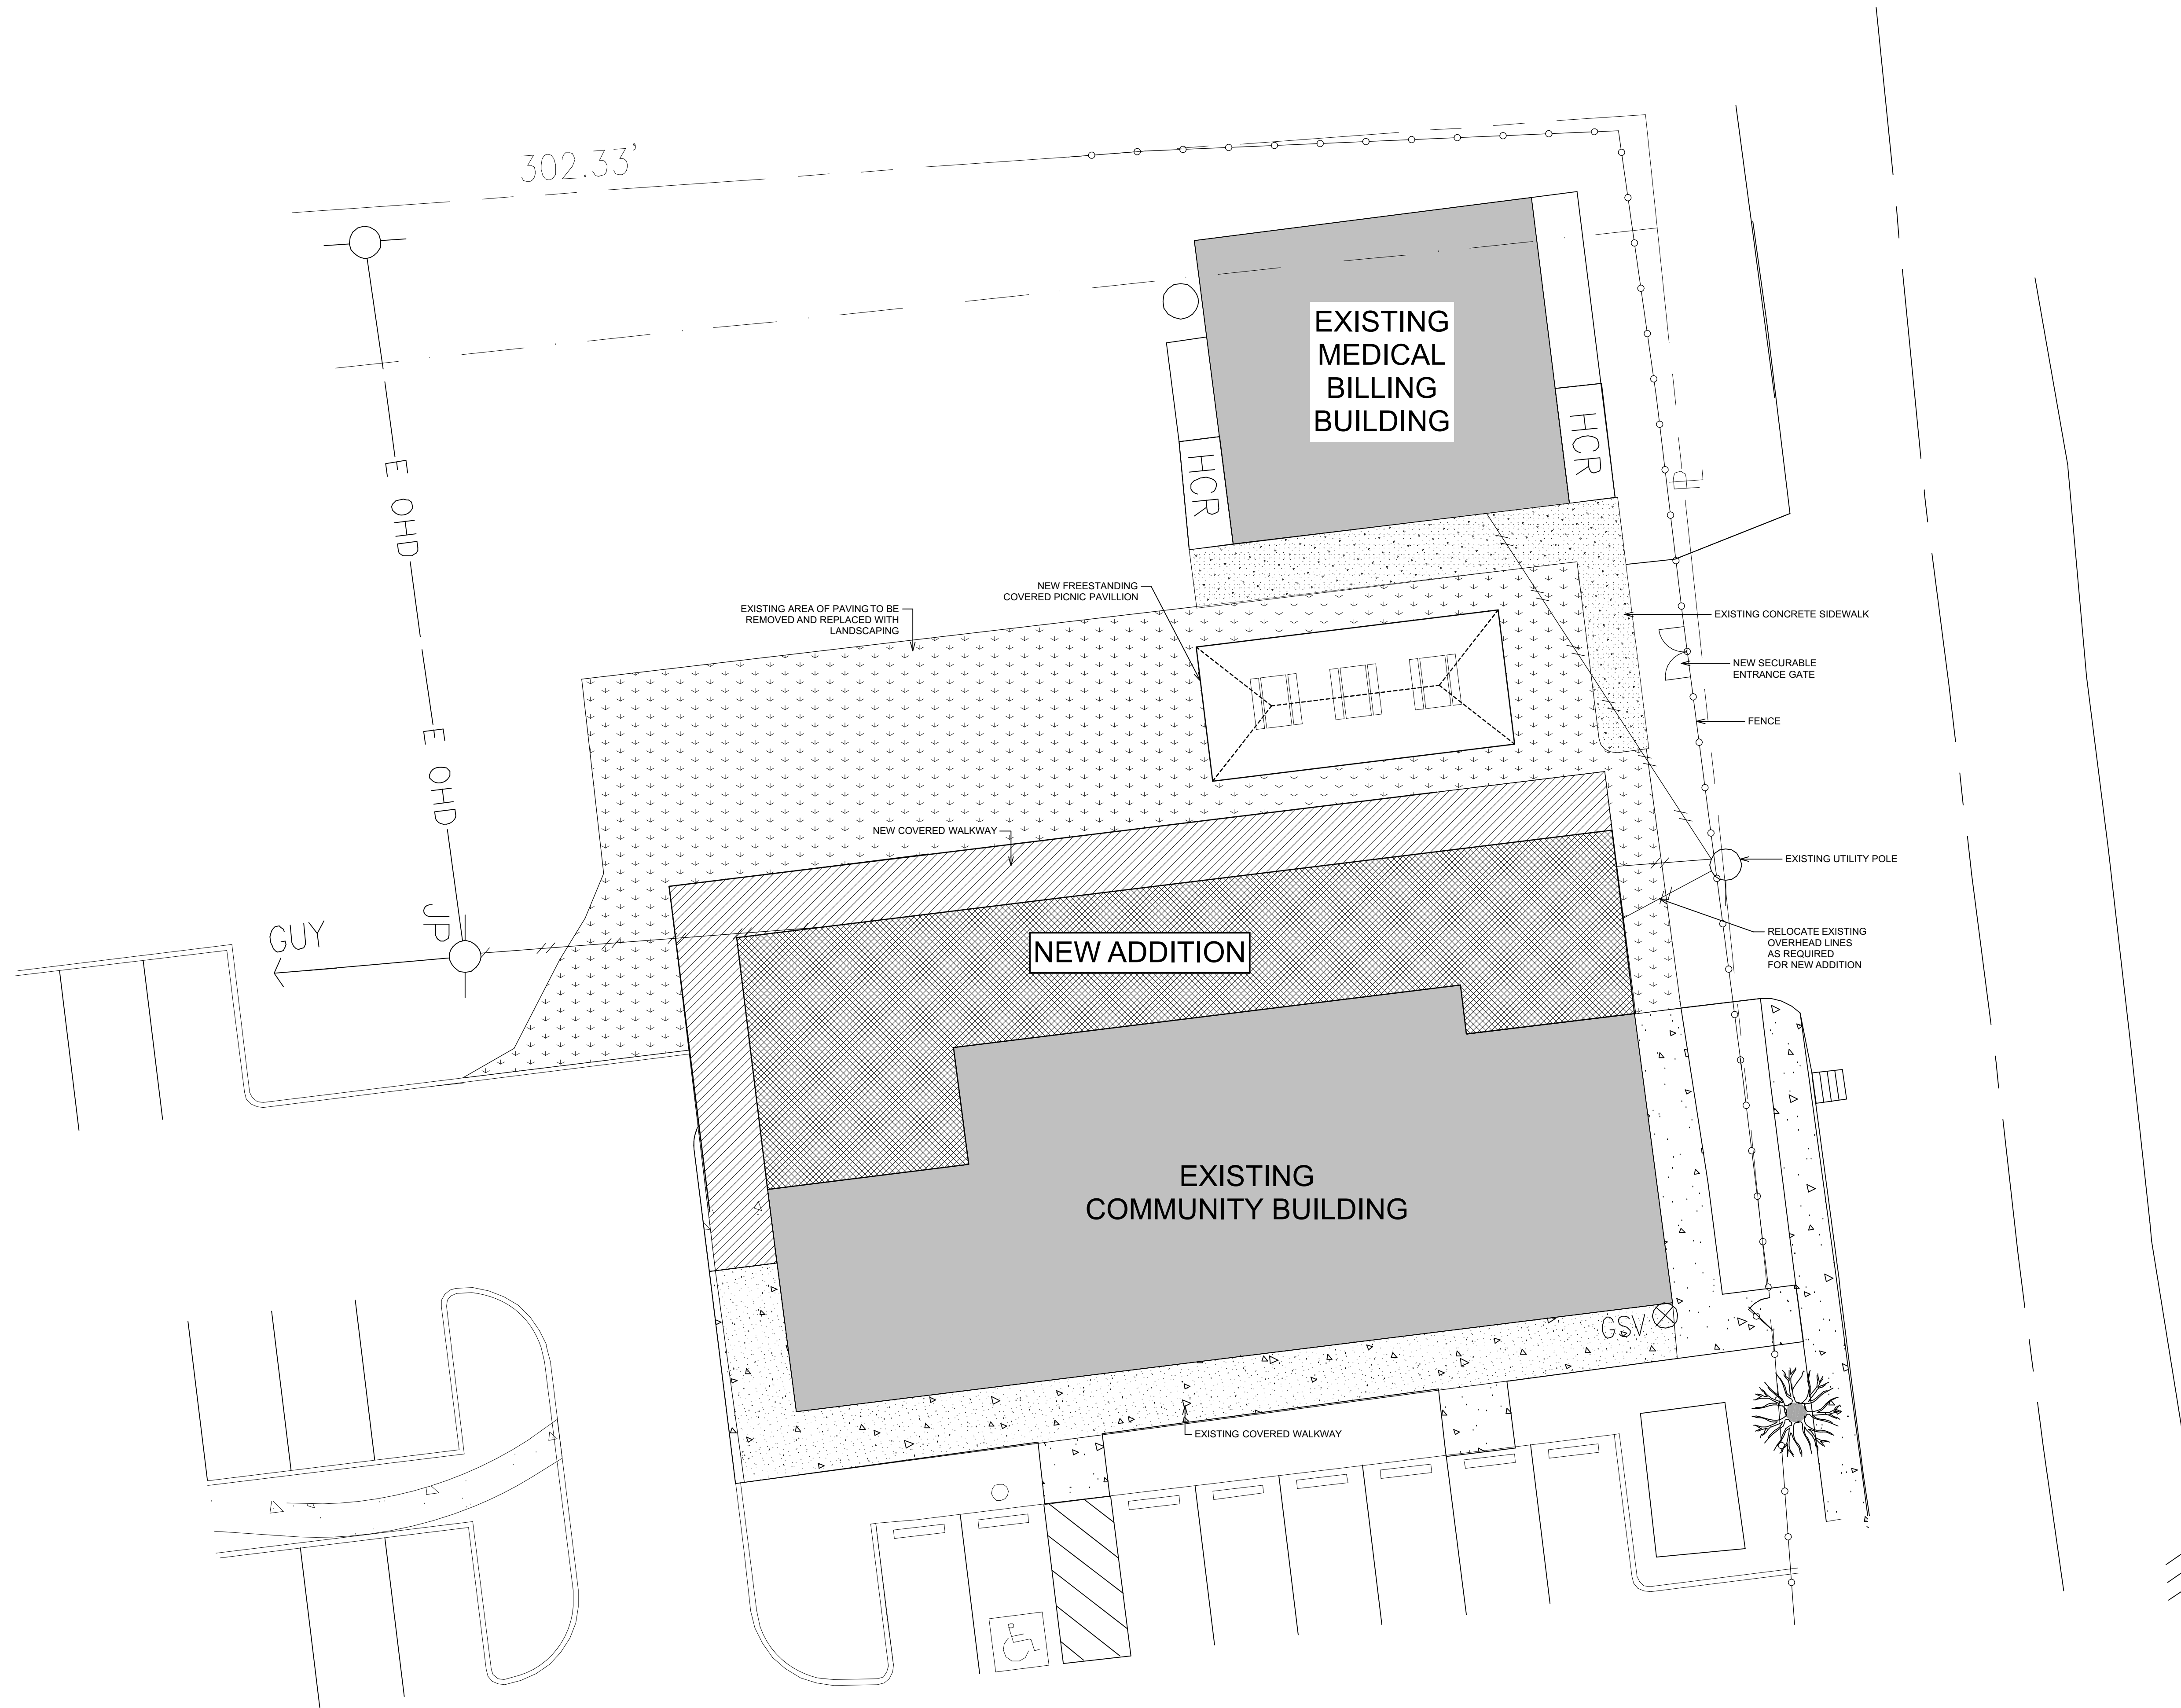PROPOSED RENOVATION AND ADDITION FOR:

KARUK TRIBE "OLD GYM" BUILDING

64236 SECOND AVE, HAPPY CAMP, CA 95039

NEW SITE PLAN

DESIGN & ENGINEERING
with framework design inc
2023 6th Street West, Ashland, WI 54806
Telephone (715) 682-0330 www.csdesignengineering.com

DESIGNED: L.D.

DRAWN: A.D.E.

SCALE: AS NOTED

DATE: JANUARY 2020

PROJECT NO.

19-3410

REVISIONS:

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SHEET NO.


C100

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NEW FLOOR PLAN

SCALE: 1/4" = 1'-0"



PROPOSED RENOVATION AND ADDITION FOR:
KARUK TRIBE "OLD GYM" BUILDING
 64236 SECOND AVE, HAPPY CAMP, CA 96039
NEW FLOOR PLAN

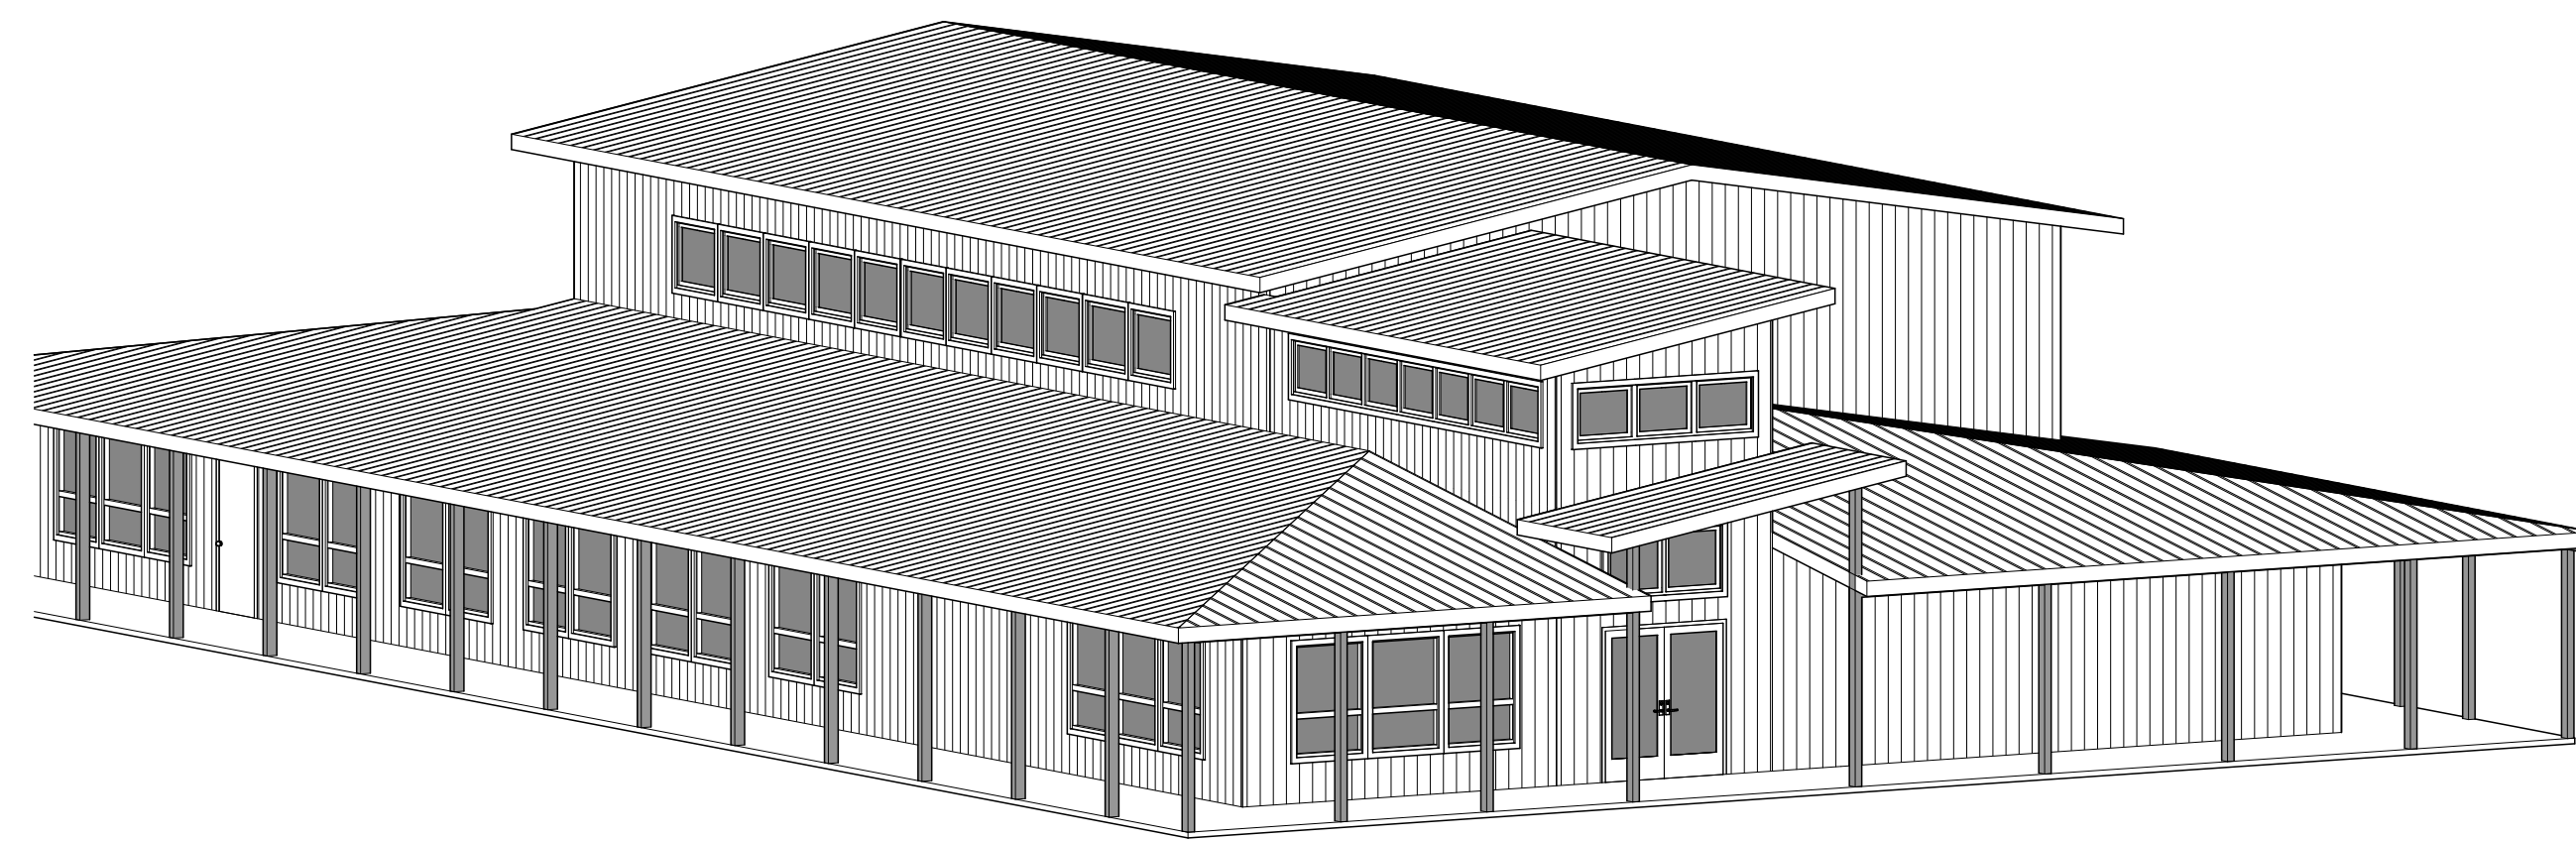
DESIGN & ENGINEERING
 with framework design inc
 C&S
 2023 6th Street West, Ashland, WI 54806
 Telephone: (715) 682-0330 www.csdengineering.com

DESIGNED: **L.D.**
 DRAWN: **A.D.E.**
 SCALE: **AS NOTED**
 DATE: **JANUARY 2020**
 PROJECT NO. **19-3410**

REVISIONS:


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SHEET NO. **A100**

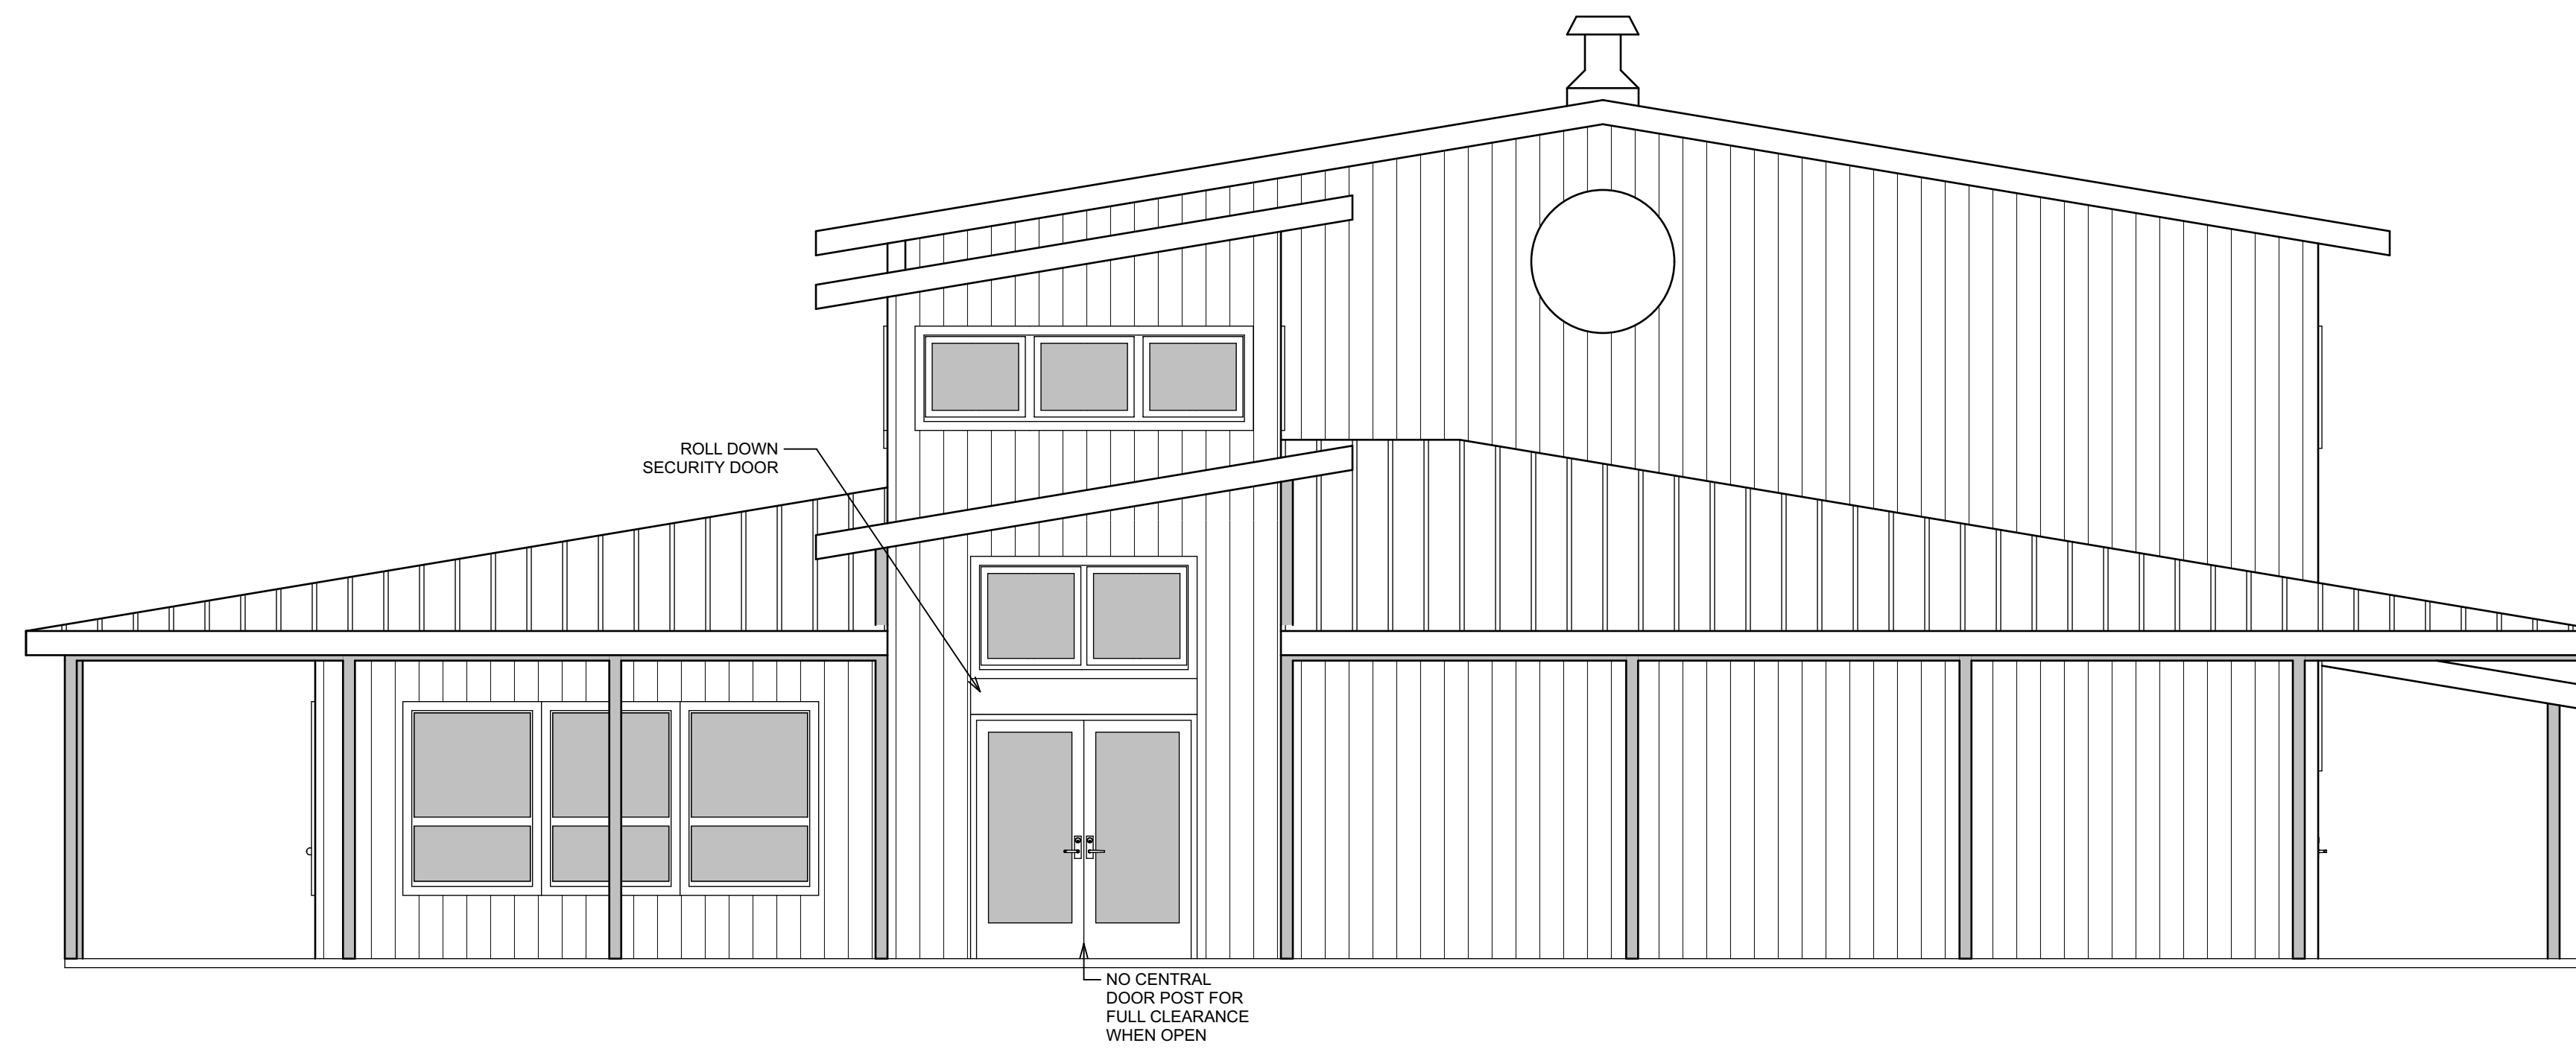


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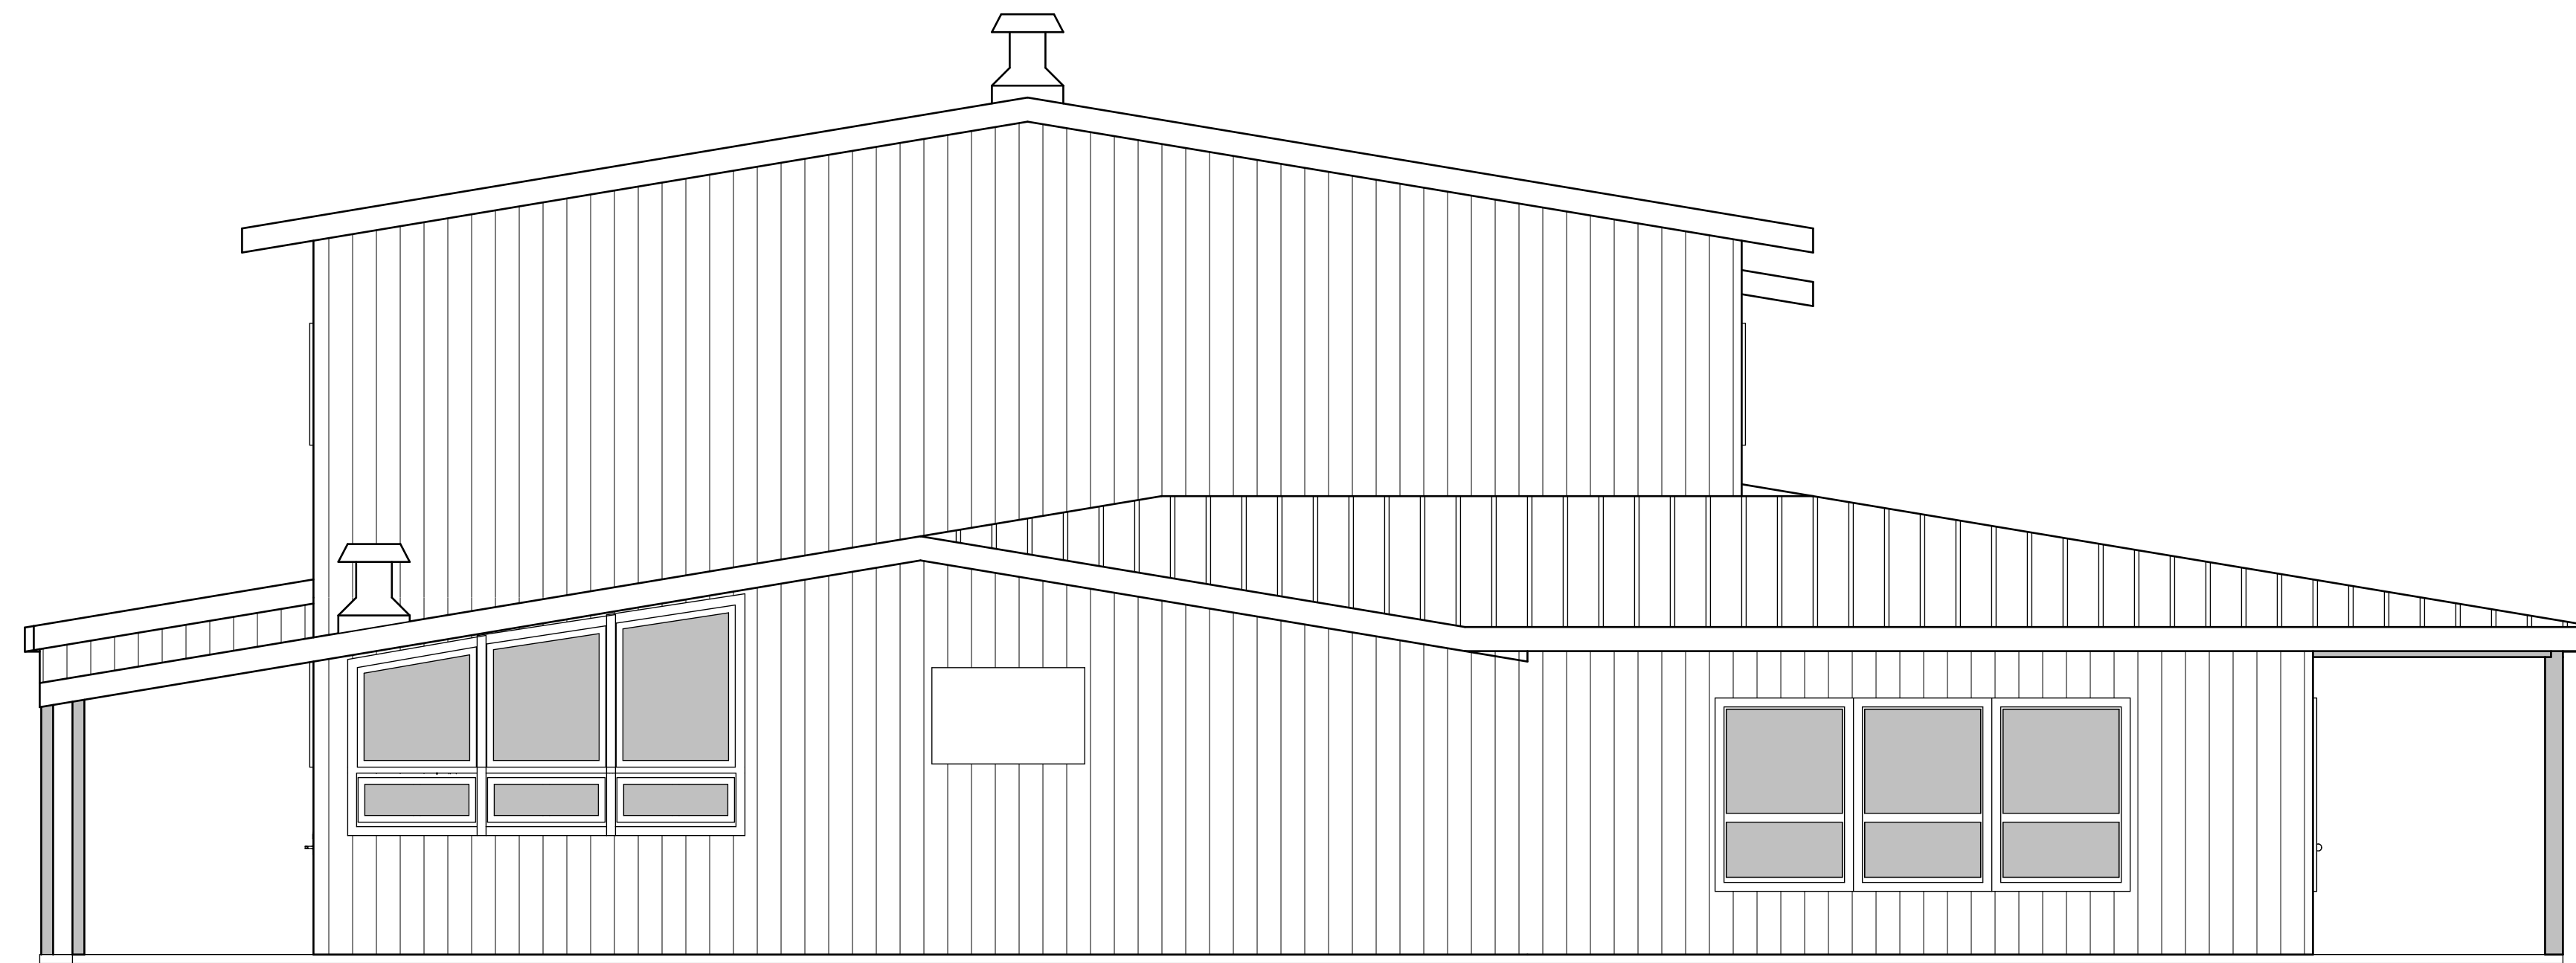
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NEW EAST ELEVATION



SCALE: 1/4" = 1'-0"



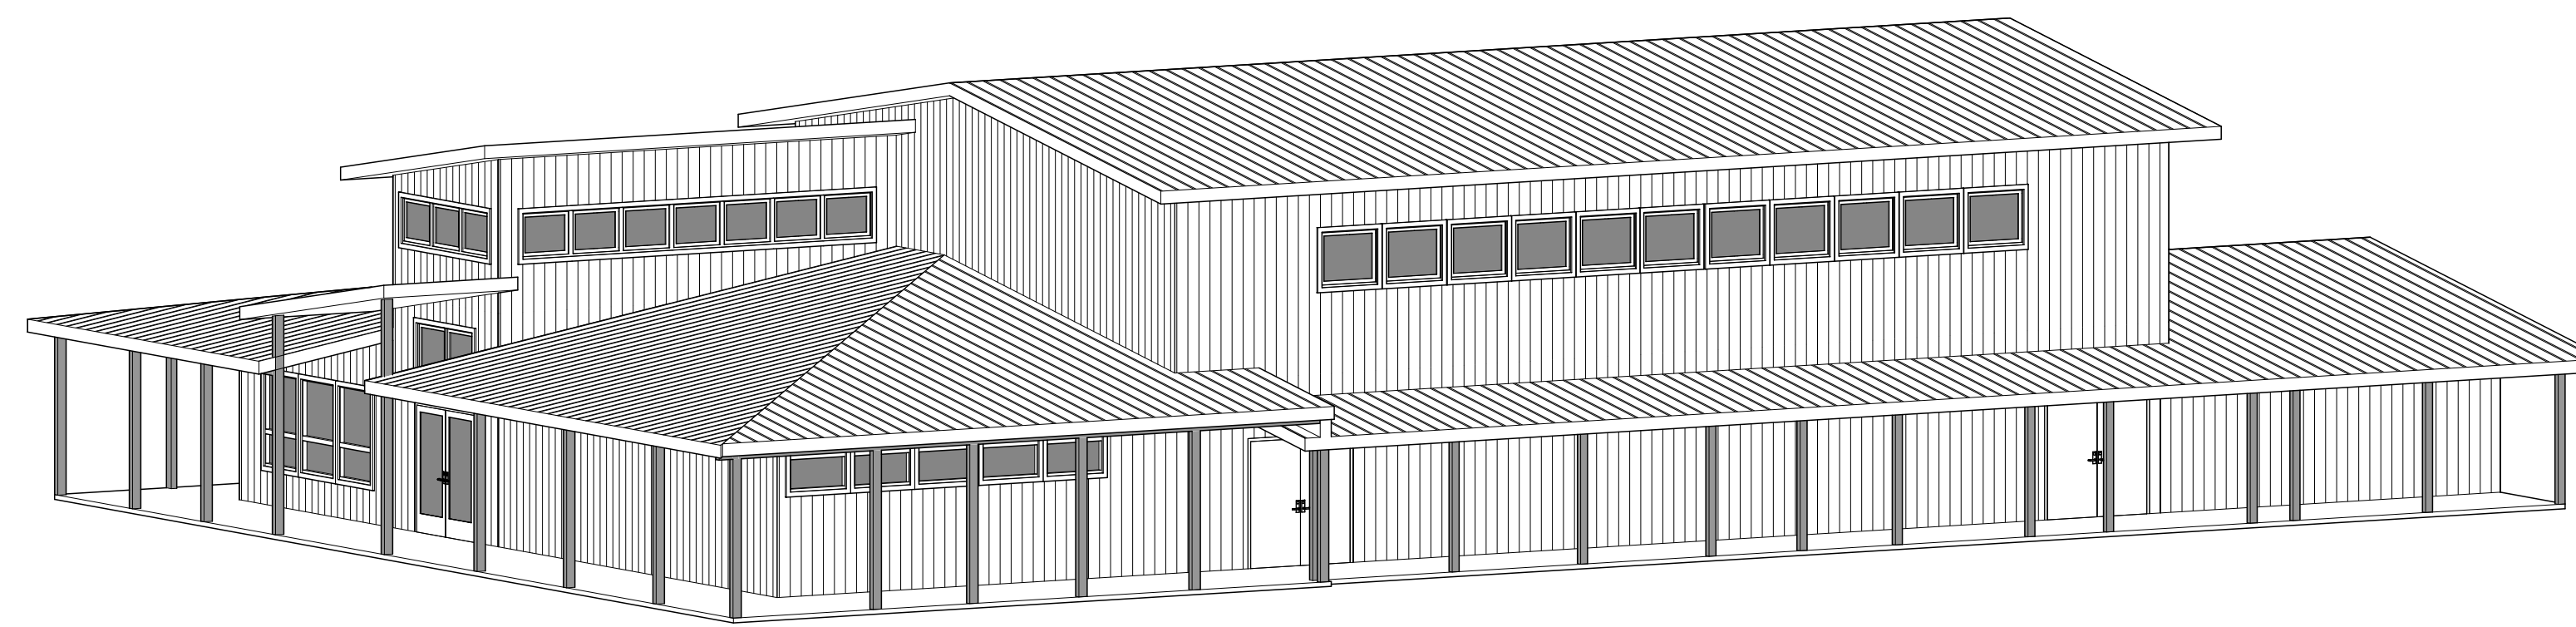

NEW NORTH ELEVATION

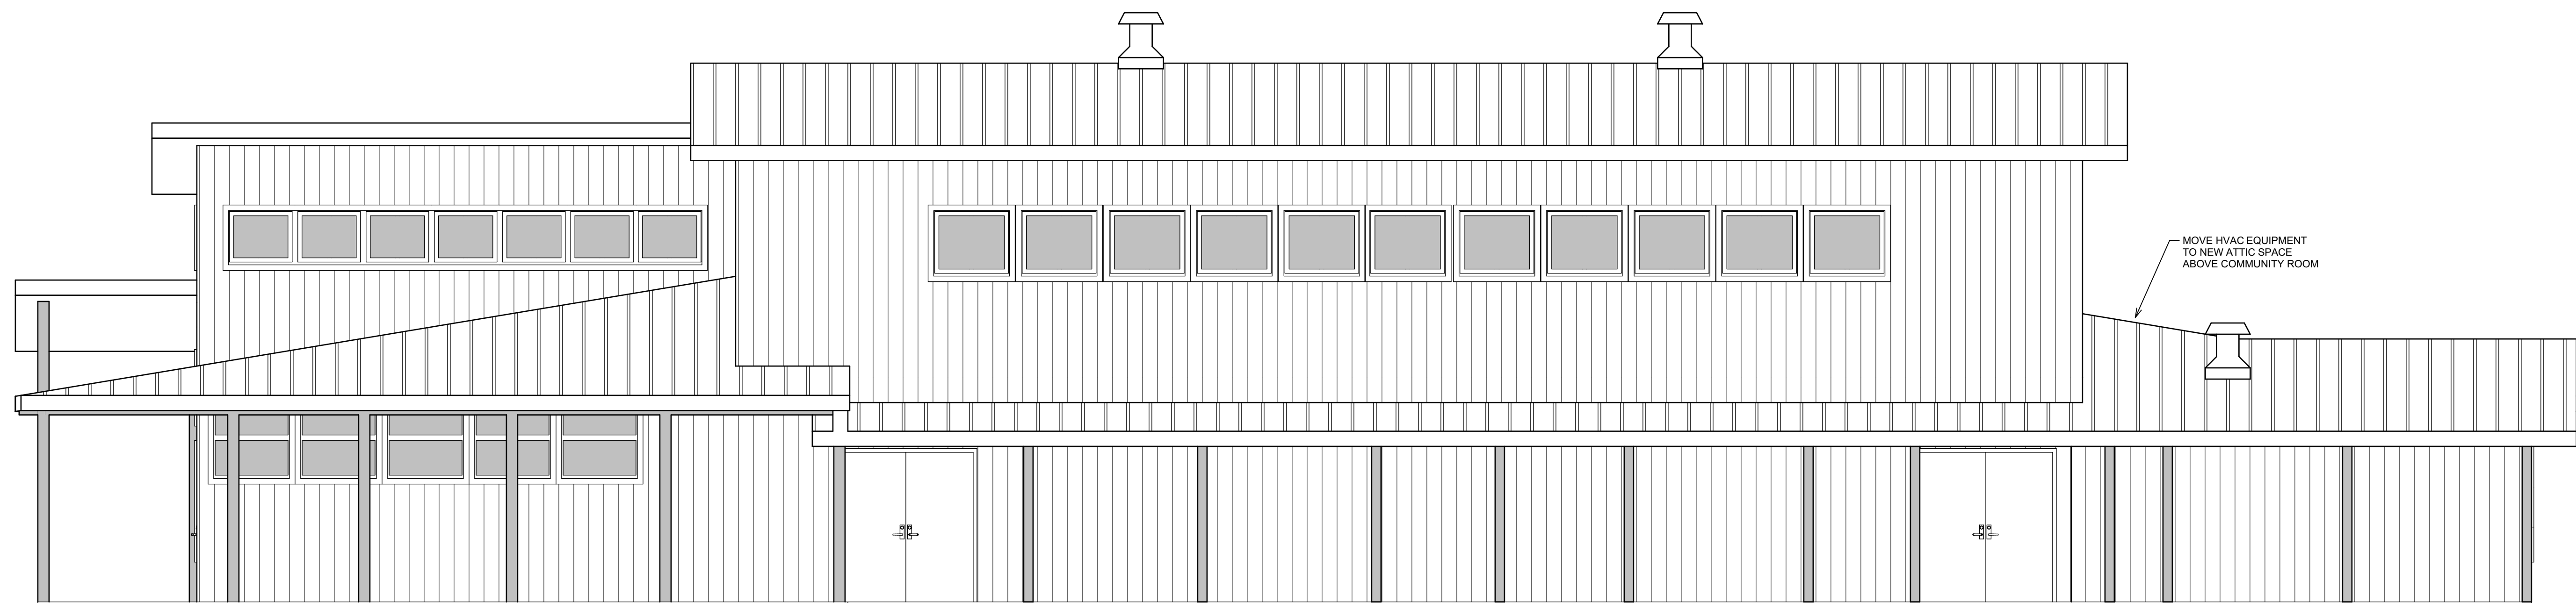SCALE: 1/4" = 1'-0"

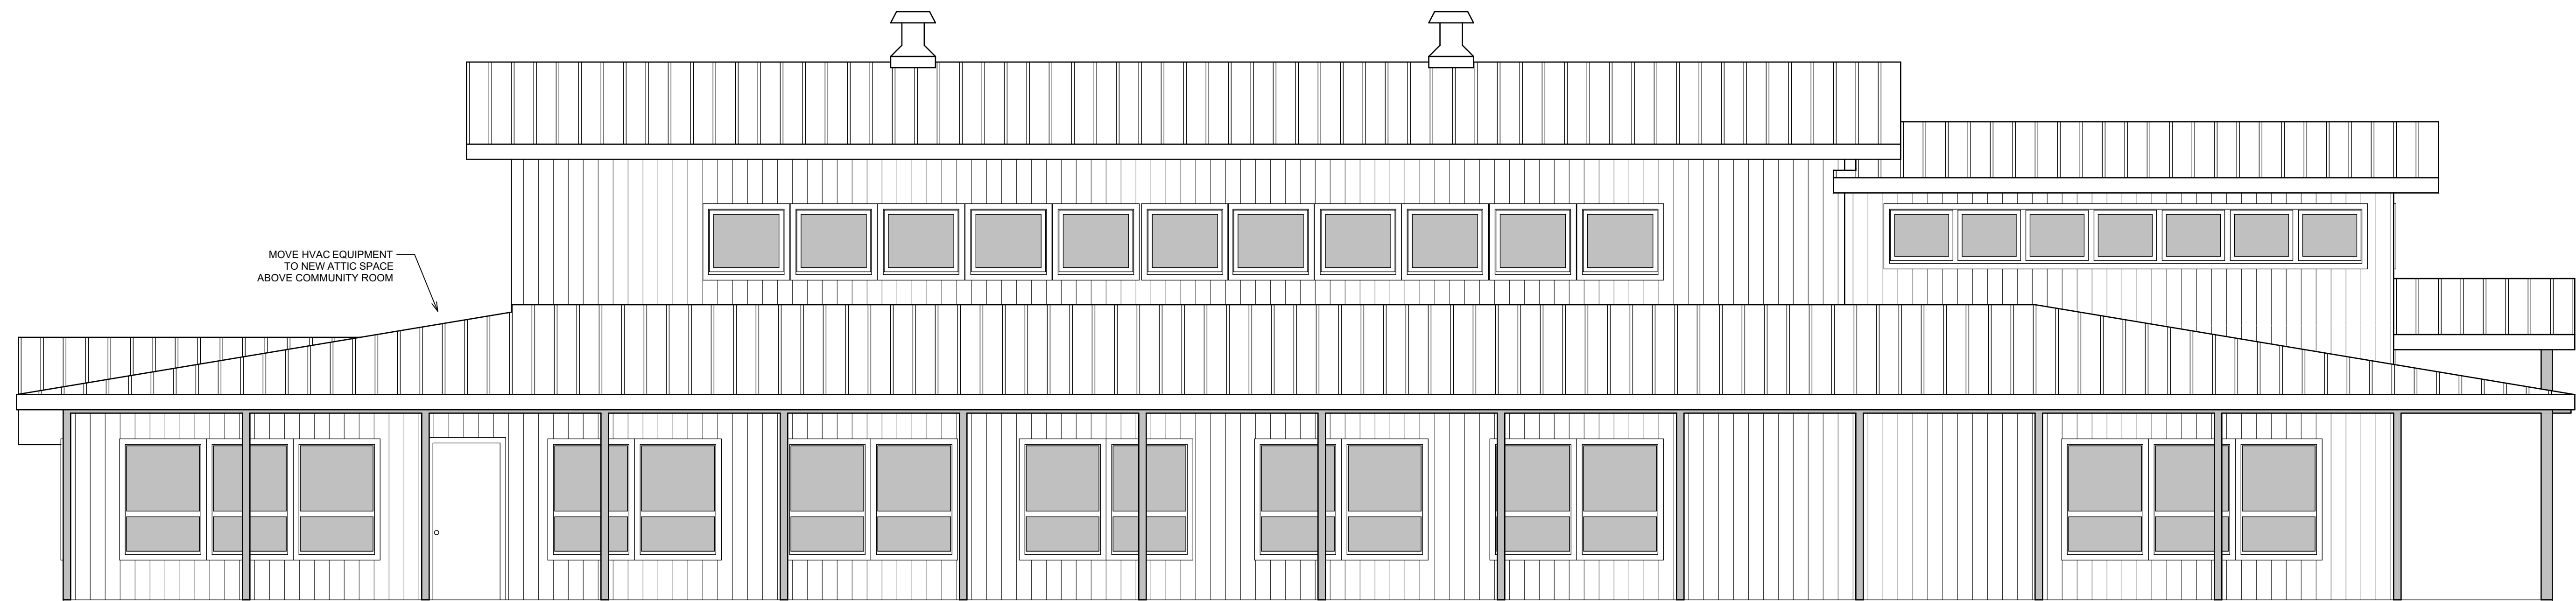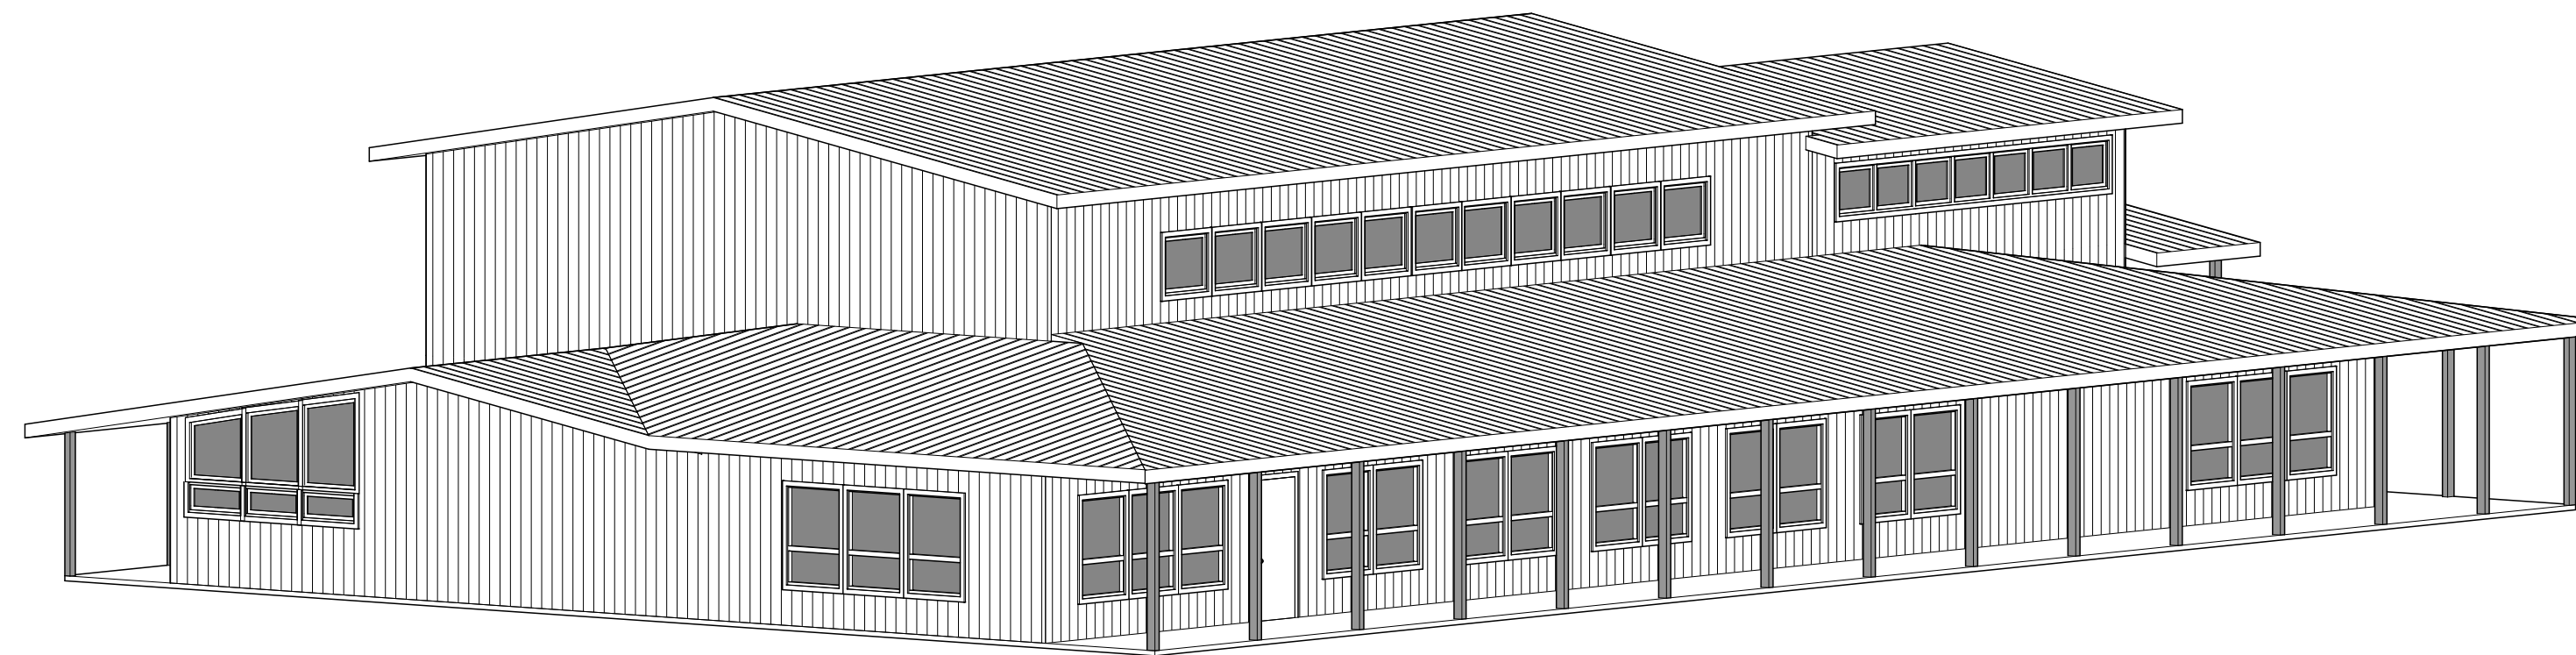

NEW WEST ELEVATION

SCALE: 1/4" = 1'-0"

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PROPOSED RENOVATION AND ADDITION FOR:

KARUK TRIBE "OLD GYM" BUILDING

64236 SECOND AVE, HAPPY CAMP, CA 96039

NEW ELEVATIONS

DESIGN & ENGINEERING

with framework design inc
2023 6th Street West, Ashland, WI 54806
Telephone (715) 682-0330 www.csdesignengineering.com



DESIGNED: **L.D.**

DRAWN: **A.D.E.**

SCALE: **AS NOTED**

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PROJECT NO.

19-3410


REVISIONS:

APPROVED:

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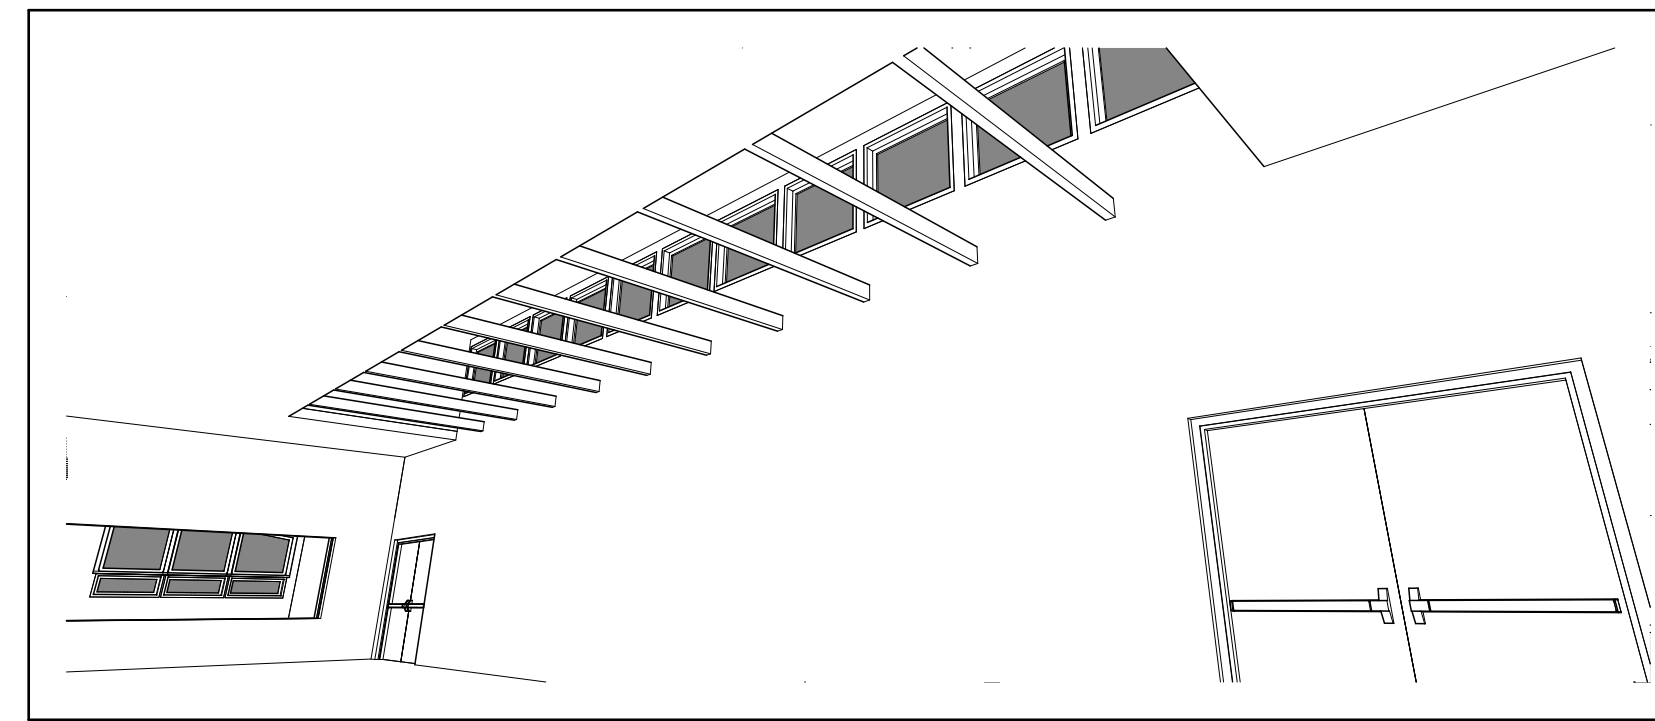
SHEET NO.

A201

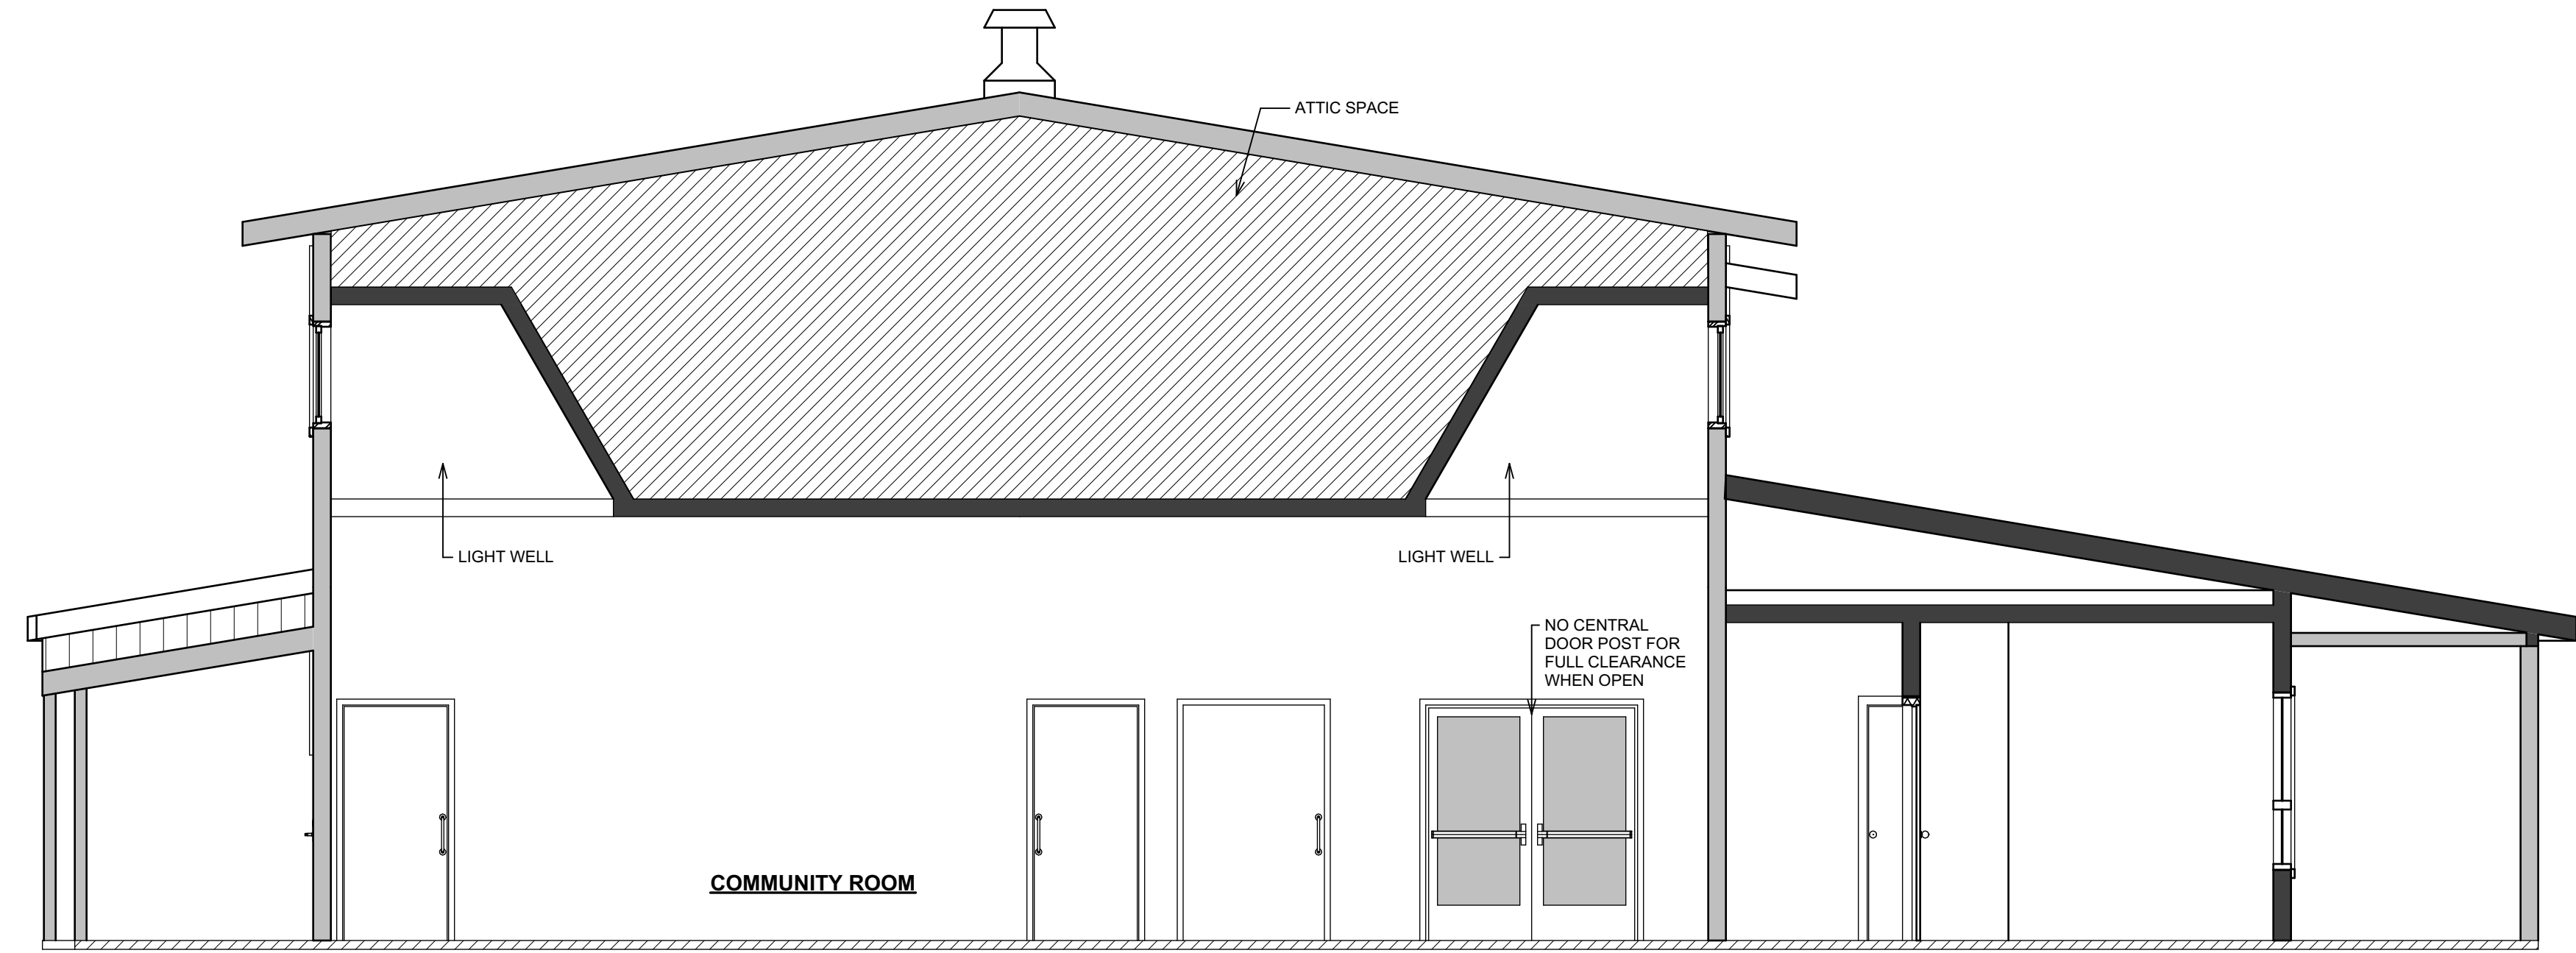

NEW CROSS SECTION

SCALE: 1/4" = 1'-0"



INTERIOR MODEL VIEW

PROPOSED RENOVATION AND ADDITION FOR:
KARUK TRIBE "OLD GYM" BUILDING

64236 SECOND AVE, HAPPY CAMP, CA 95039

CROSS SECTION

DESIGN & ENGINEERING
 with framework design inc
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DESIGNED: **L.D.**

DRAWN: **A.D.E.**

SCALE: **AS NOTED**

DATE: **JANUARY 2020**

PROJECT NO.

19-3410

REVISIONS:

APPROVED:

NOT FOR CONSTRUCTION OR FINAL PRICING

SHEET NO.

A300